




SOILS

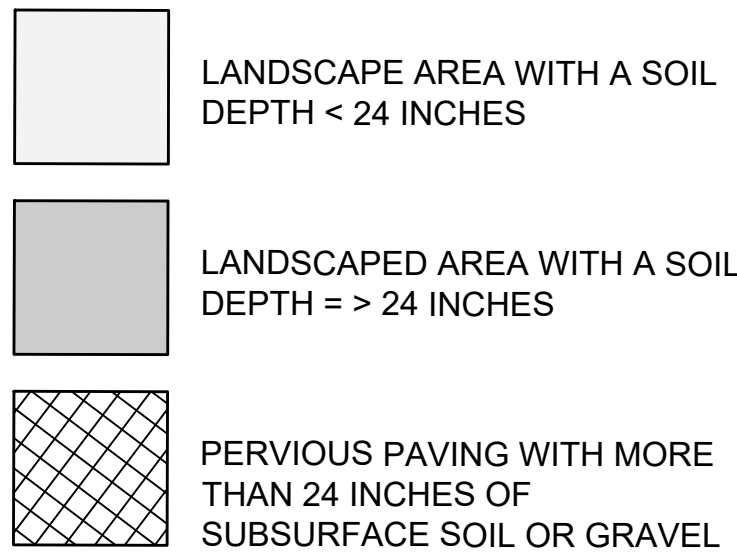


GROUNDCOVERS

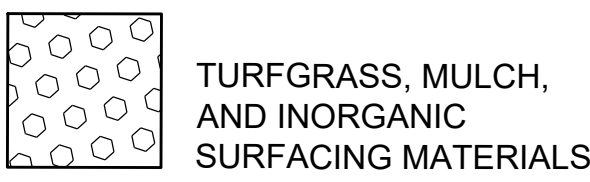

PLANTS

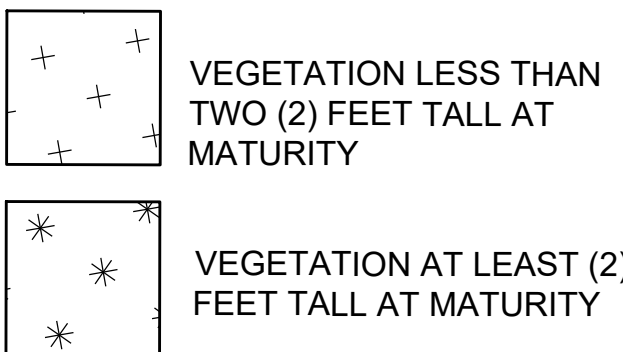


TREES

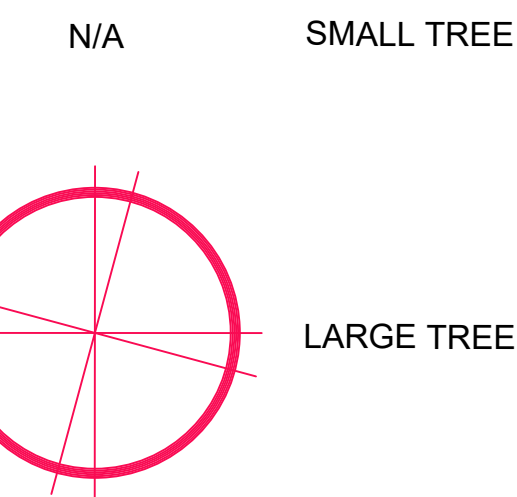

ENGINEERED LANDSCAPE



BONUS CREDITS

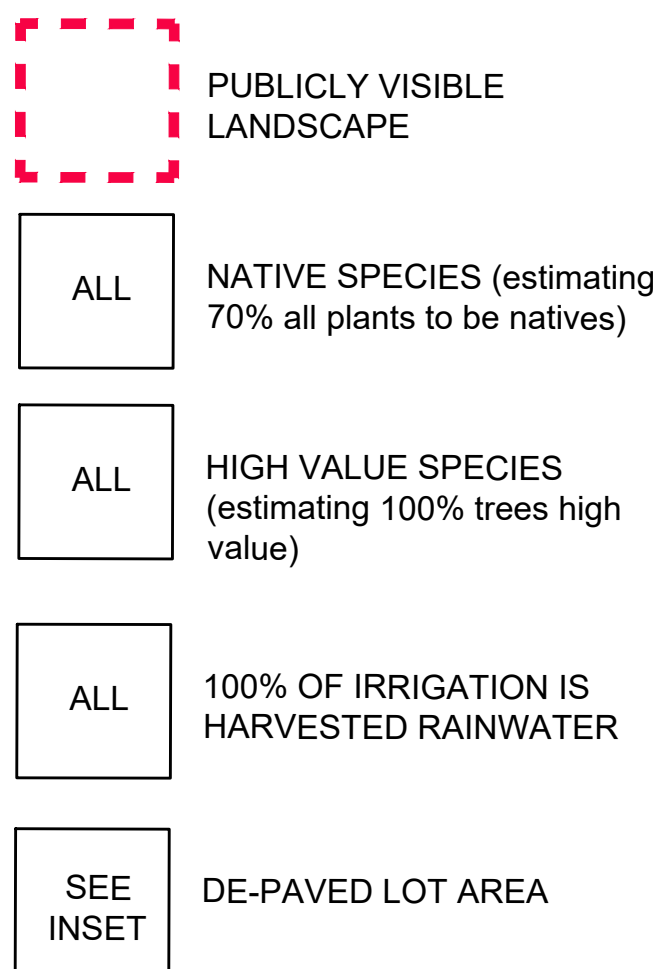

WEBSTER AVENUE

BEACH AVENUE

COLUMBIA STREET

DEPAVED AREAS (2,916 SF)

DIRECTIONS:
1. Enter the Lot Area in square feet to the right >>>
2. Enter the area in square feet or the number of landscape elements

Landscape area with a soil depth less than 24 inches (enter square feet)	385
w/ BONUS CREDITS - Depaved	
Landscape area with a soil depth equal to or greater than 24 inches (enter square feet)	4,231
w/ BONUS CREDITS - Depaved	
Landscape area with a soil depth equal to or greater than 24 inches (enter square feet)	508
w/ BONUS CREDITS - Depaved	
Pervious Paving with more than 24 inches of subsurface soil or gravel (enter square feet)	1,117
w/ BONUS CREDITS - Depaved	
Turf grass, mulch, and inorganic surfacing materials (enter square feet)	1,049
w/ BONUS CREDITS - Stormwater Irrigation, Depaved	
Vegetation less than two (2) feet tall at maturity (enter square feet)	385
w/ BONUS CREDITS - Stormwater Irrigation	
Vegetation at least two (2) feet tall at maturity (enter number of individual plants)	978
w/ BONUS CREDITS - Stormwater Irrigation	
Vegetation at least two (2) feet tall at maturity (enter number of individual plants)	168
w/ BONUS CREDITS - Publicly Visible, Native Species, Stormwater Irrigation	
Large Tree (enter number of trees)	8
w/ BONUS CREDITS - High Value, Stormwater Irrigation	
Large Tree (enter number of trees)	5
w/ BONUS CREDITS - Publicly Visible, High Value, Stormwater Irrigation	
Vegetated Wall (enter square feet)	678

Area or Number	Sq Ft Credit	Multiplier	Weighted Area	Score Value
50,090				
385	actual sq ft	0.4	154	0.003
4,231	actual sq ft	0.7	2961.7	0.059
508	actual sq ft	0.7	355.6	0.007
1,117	actual sq ft	0.6	670.2	0.013
1,049	actual sq ft	0.3	314.7	0.006
385	actual sq ft	0.3	115.5	0.002
978	12	0.4	4694.4	0.094
168	12	0.5	1008	0.020
8	450	0.9	3240	0.065
5	450	0.9	2025	0.040
678	actual sq ft	0.1	67.8	0.001
Green Score =				0.312

NR & UR	MR3 & MR4	MRS, MR6, & HR	FAB, CC, CB, CI
0.35	0.25	0.20	0.20
0.40	0.3	0.25	-
0.312	0.312	0.312	0.312

Required Score:
Target Score:
Actual Green Score:

GREEN SCORE = 0.312

NOT FOR CONSTRUCTION

City Stamp

SCALE: 1" = 10'-0"

10' 5' 0 10' 20'

96-E-1, 96-E-1A, 96-E-2, 96-E-5,
96-E-4,
96-E-3, 96-F-2, 96-F-3, 96-F-4, 96-F-5,
96-F-6, 96-F-9



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Boynton Gateway
495 Columbia Street
Somerville, MA 02143

REVISIONS:

No.	Date	Description
1	12/15/21	PSUF Responses

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Date	Issued For:
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PROJECT NO 5081

DRAWN BY NV

CHECKED BY IR

SHEET TITLE:

Landscape Green**Scorecard****GS.1**

TREE REMOVAL NOTES

- THIS SHEET DESCRIBES EXISTING TREE REMOVAL WORK ONLY. REFER TO CIVIL ENGINEER'S DRAWINGS FOR COMPLETE SITE PREP AND DEMO REQUIREMENTS.
- TREE REMOVAL SCOPE SHALL INCLUDE THE FELLING, CUTTING, AND SATISFACTORY DISPOSAL OF ALL TREES, STUMPS AND VEGETATIVE DEBRIS PRODUCED THROUGH THE CLEARING OPERATIONS.
- FELL TREES IN SUCH A WAY AS TO NOT INJURE TREES TO BE SAVED. EXCAVATION OR GRADING WITHIN THE BRANCH SPREAD OF TREES TO BE SAVED SHALL BE PERFORMED ONLY UNDER THE DIRECTION OF THE OWNER'S REPRESENTATIVE UNLESS OTHERWISE DIRECTED.
- STUMPS TO BE REMOVED OUTSIDE THE TREE PRESERVATION AREA SHALL BE GRUBBED TO THEIR FULL DEPTH. ROOTS 3 INCHES AND LARGER SHALL BE REMOVED TO A DEPTH OF 2 FEET BELOW FINISHED GRADE. STUMPS SHALL BE LEGALLY DISPOSED OF OFF-SITE.
- CONTRACTOR SHALL TAG ALL TREES TO BE REMOVED AND VERIFY WITH OWNER'S REPRESENTATIVE PRIOR TO THE START OF DEMOLITION.
- FOR ALL SITE PREP AND DEMO WORK OUTSIDE TREE PROTECTION AREA, SEE CIVIL ENGINEER'S DRAWINGS.
- BEFORE THE START OF ANY WORK ON THE SITE, PRECEDING THE ARRIVAL OF EQUIPMENT, MATERIALS OR VEHICLES TO THE SITE, AND PRIOR TO THE COMMENCEMENT OF ANY CLEARING ON THE SITE, THE CONTRACTOR SHALL ARRANGE A PRE-CONSTRUCTION CONFERENCE ON THE SITE WITH THE OWNER'S REPRESENTATIVE AND THE LANDSCAPE ARCHITECT TO IDENTIFY TREES AND SHRUBS THAT ARE TO BE REMOVED. DO NO CLEARING WITHOUT A CLEAR UNDERSTANDING OF EXISTING CONDITIONS TO BE PRESERVED. REFER TO SPECIFICATION SECTION 01 56 39 FOR MORE INFORMATION.
- REMOVE AND DISPOSE OF DEBRIS AS DIRECTED BY THE OWNER.

TREE PROTECTION LEGEND

- EXISTING TREE
- TREE TO BE REMOVED
- N/A TREE PROTECTION FENCE, TYP.

NOTE:
TREE REVIEW WALK HELD WITH CITY ARBORIST 10/14/2021

EXISTING TREE SCHEDULE

Reference	Species	DBH	Condition	Land	Comments	Action
A	Japanese Tree Lilac	2.7"	Poor	public	nearly dead, scheduled to be removed by city	Remove
B	American Elm	8"	Fair	public	snapped limbs / dead wood	Remove
C	Cherry / Plum	5"	Poor	public	snapped limbs / dead wood	Remove
D	Cherry / Plum	15"	Good	public		Remove
E	Pin Oak	13"	Good	private		Remove
F	Linden	13"	Fair	private	dead wood	Remove
G	Pear	7"	Good	private	concrete fill against trunk	Remove

PUBLIC EXISTING TREE CALIPER TO BE REMOVED ON SITE

Quantity of Trees	Size	Subtotal Caliper
1	5"	5"
1	8"	8"
1	15"	15"

Total Caliper: 28" of significant existing tree caliper removed

PROPOSED REPLACEMENT TREES ON SITE

Symbol	Qty	Botanical Name	Common Name	Caliper Size	Notes
CL	4	<i>Celtis laevigata</i>	Sugarberry	3-3.5" Caliper	
QR	5	<i>Quercus rubra</i> var. <i>borealis</i>	Northern Red Oak	3-3.5" Caliper	
UAP	4	<i>Ulmus americana</i> 'Princeton'	American Elm	3-3.5" Caliper	
TA	8	<i>Tilia Americana</i>	American Basswood	3-3.5" Caliper	

PRIVATE EXISTING TREE CALIPER TO BE REMOVED ON SITE


Quantity of Trees	Size	Subtotal Caliper
2	13"	26"
1	7"	7"

Total Caliper: 33" of significant private existing tree caliper removed

TREE CALIPER PROPOSED ON SITE

Quantity of Trees	Caliper In	Subtotal Caliper
21	3.5"	73.5"

Total Caliper: 73.5" of tree caliper proposed

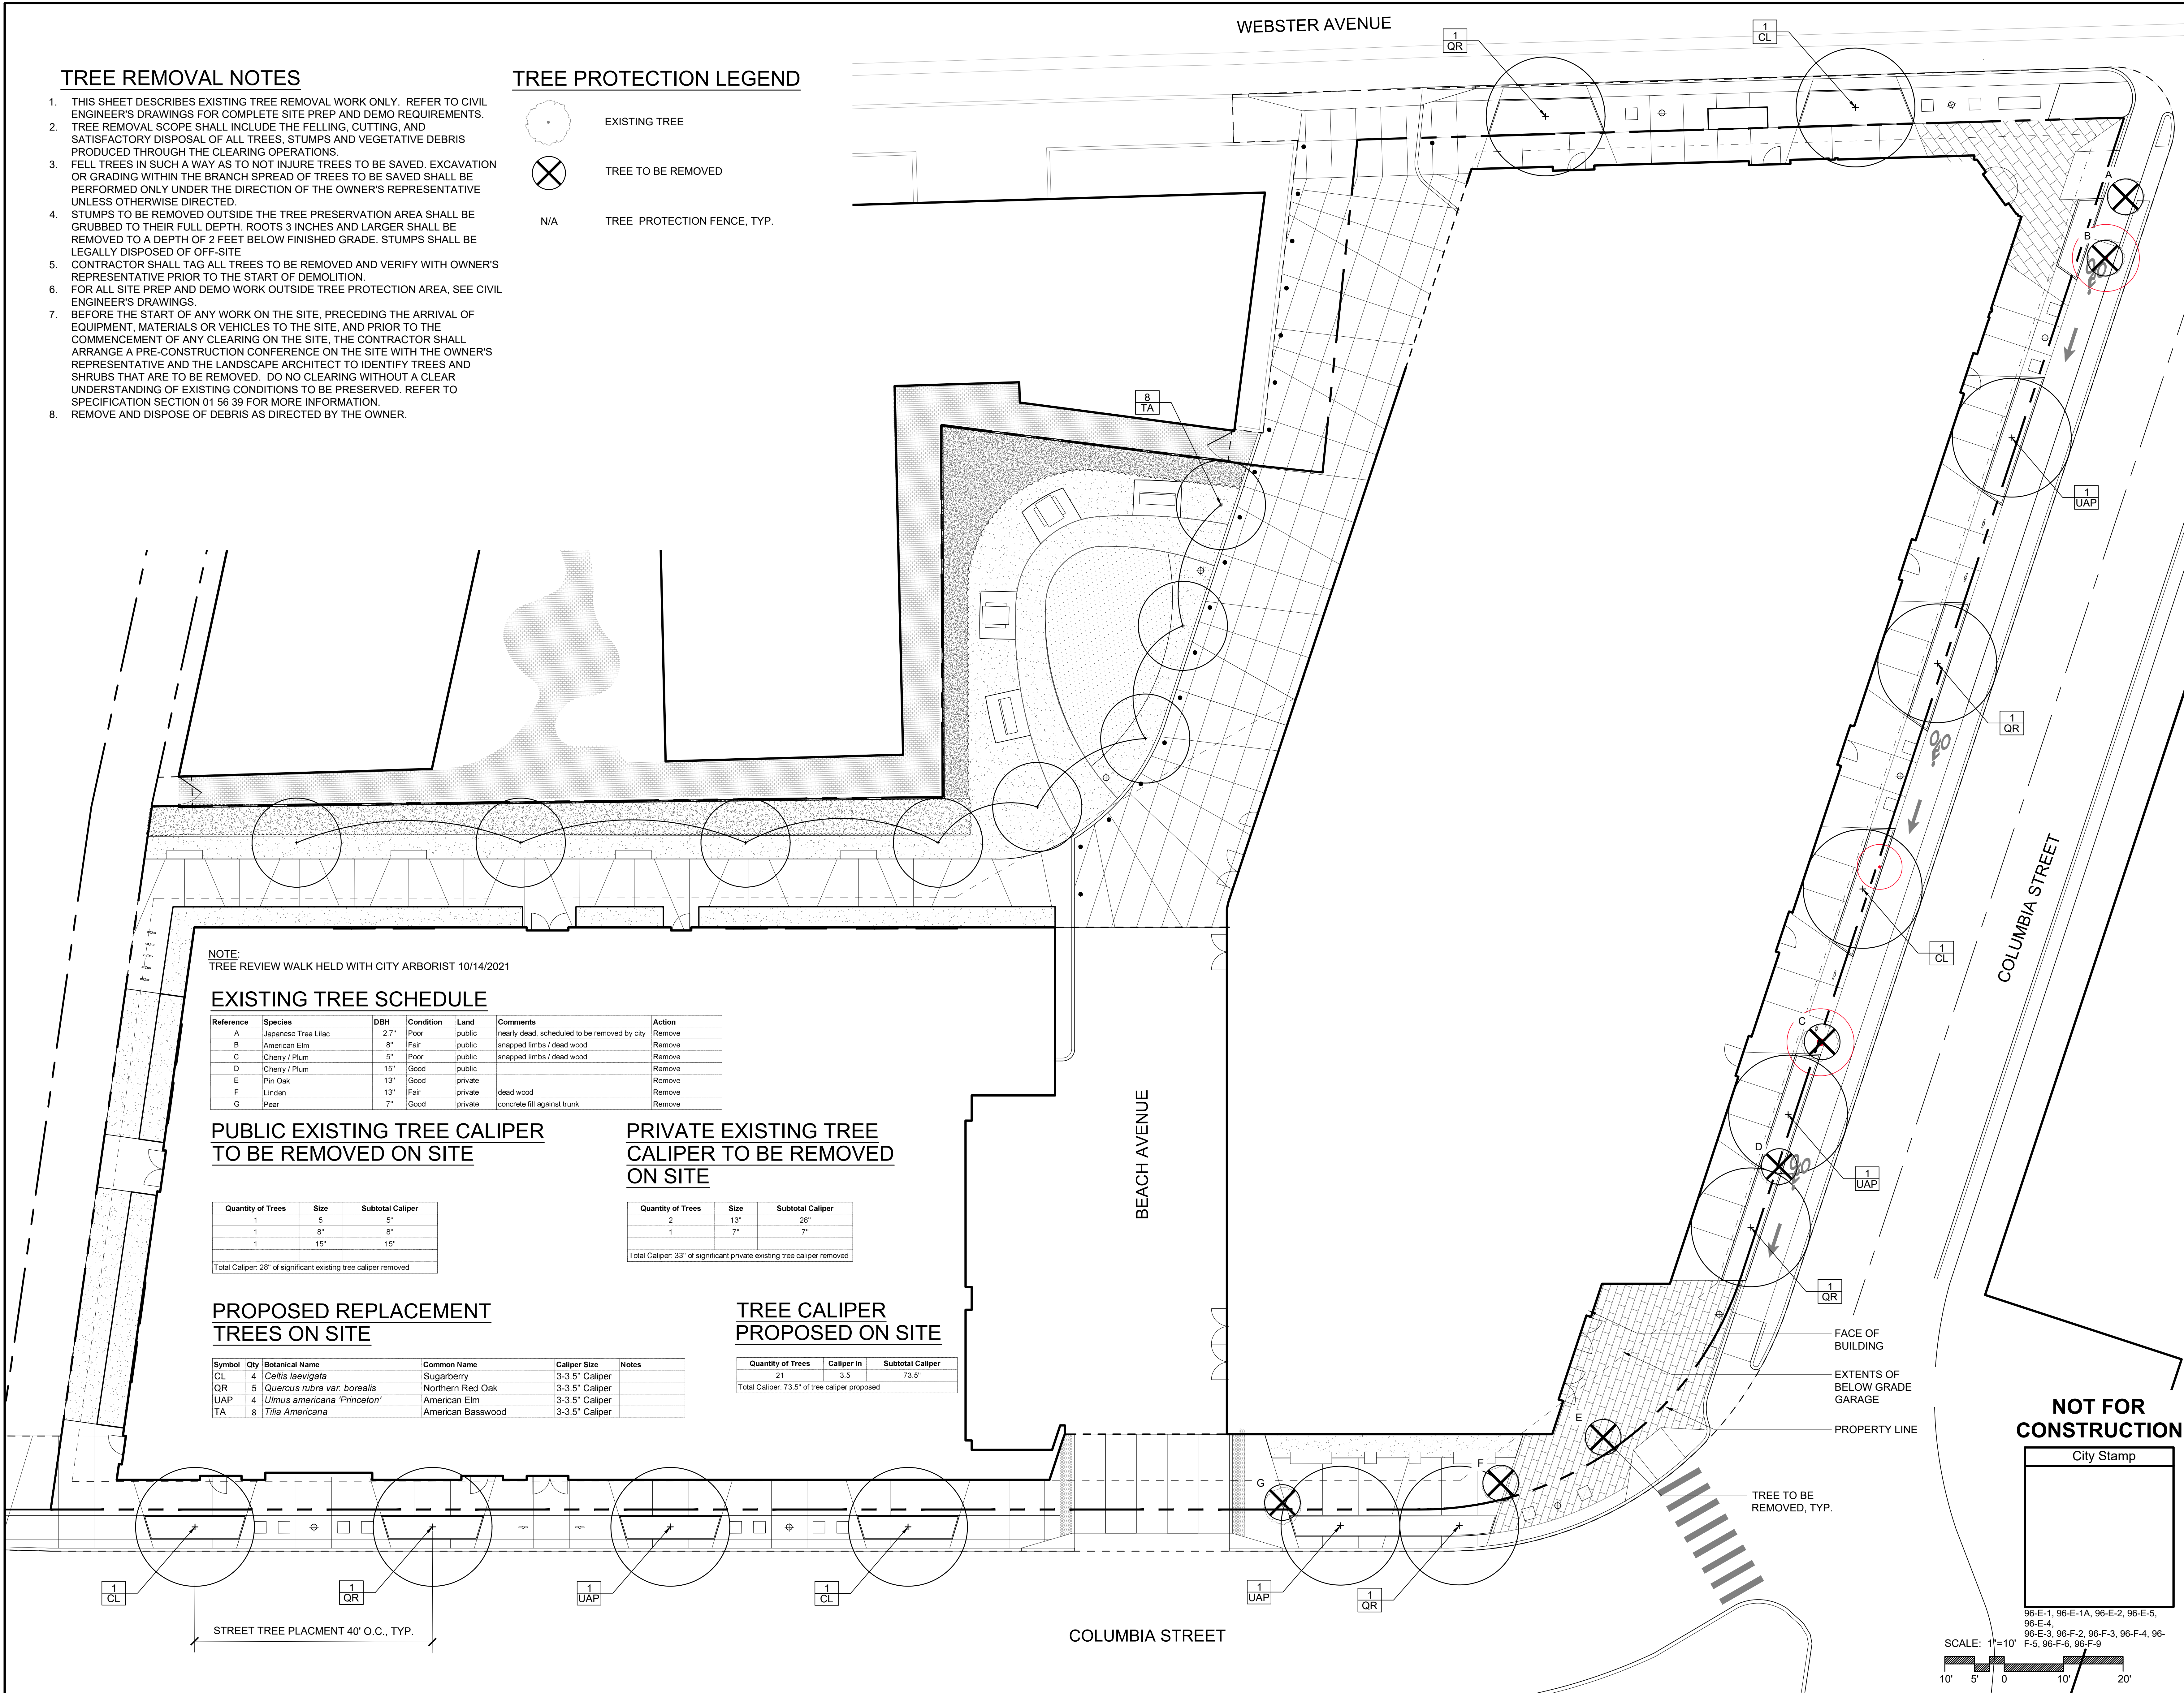

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PROJECT NO 5081
DRAWN BY NV
CHECKED BY IR

SHEET TITLE:

**Landscape
Existing
Tree Plan**

GS.2

LANDSCAPE MATERIAL NOTES

1. THE CONTRACTOR SHALL REVIEW ALL DRAWINGS AND SPECIFICATIONS TO DETERMINE THE TOTAL SCOPE OF WORK AND ALL REQUIRED COORDINATION.

2. THE CONTRACTOR IS RESPONSIBLE FOR A THOROUGH SITE EXAMINATION TO SATISFY HIM OR HERSELF AS TO THE ACTUAL SITE CONDITIONS BEFORE SUBMISSION OF BIDS.

3. CONTRACTOR SHALL VERIFY ALL EXISTING UTILITY LOCATIONS PRIOR TO EXCAVATION.

4. CONTRACTOR SHALL ARRANGE PRE-INSTALLATION CONFERENCES AT PROJECT SITE FOR STONE WALLS AND PAVEMENT WORK. ATTENDEES SHALL INCLUDE OWNER'S REPRESENTATIVE, LANDSCAPE ARCHITECT, GENERAL CONTRACTOR AND ALL SUB-CONTRACTORS DIRECTLY CONCERNED WITH THE WORK.


5. CONTRACTOR SHALL PREPARE SUBMITTALS TO THE LANDSCAPE ARCHITECT FOR ALL COMPONENTS OF THE FINISHED WORK, INCLUDING SHOP DRAWINGS, PRODUCT DATA, MATERIAL CERTIFICATIONS, MIX DESIGNS AND SAMPLES.

6. CONTRACTOR SHALL FURNISH AND INSTALL CONSTRUCTED SAMPLES (MOCK-UPS) DEMONSTRATING ALL COMPONENTS OF THE DESIGN, INCLUDING FINISHED EXPOSED EDGES AND SURFACES, COLORS AND JOINTING FOR REVIEW AND APPROVAL BY THE LANDSCAPE ARCHITECT PRIOR TO
- CONSTRUCTING FINAL WORK. MOCK-UPS MAY BE PART OF THE FINAL CONSTRUCTION. MOCK-UPS SHALL BE MAINTAINED AND PROTECTED THROUGHOUT THE DURATION OF THE PROJECT AND WILL SERVE AS PROJECT STANDARD. CONTRACTOR SHALL DEMOLISH AND RECONSTRUCT MOCK-UP UNTIL APPROVAL FROM LANDSCAPE ARCHITECT. THE CONTRACTOR IS RESPONSIBLE FOR ALL DAMAGE INSIDE OR OUTSIDE OF LIMIT OF WORK LINE DUE TO HIS/HER CONSTRUCTION OPERATIONS.

7. STORAGE AREAS FOR THE GENERAL CONTRACTOR'S EQUIPMENT AND MATERIALS SHALL BE LOCATED WITHIN THE LIMITS OF WORK AS APPROVED BY THE LANDSCAPE ARCHITECT.

8. WHERE NEW PAVING MEETS EXISTING PAVING, MEET LINE AND GRADE OF EXISTING WITH NEW CONSTRUCTION.

9. AT ALL LOCATIONS WHERE EXISTING BITUMINOUS CONCRETE PAVEMENT ABUTS NEW CONSTRUCTION, THE EDGE OF THE EXISTING PAVEMENT SHALL BE SAWCUT TO A CLEAN SMOOTH EDGE.

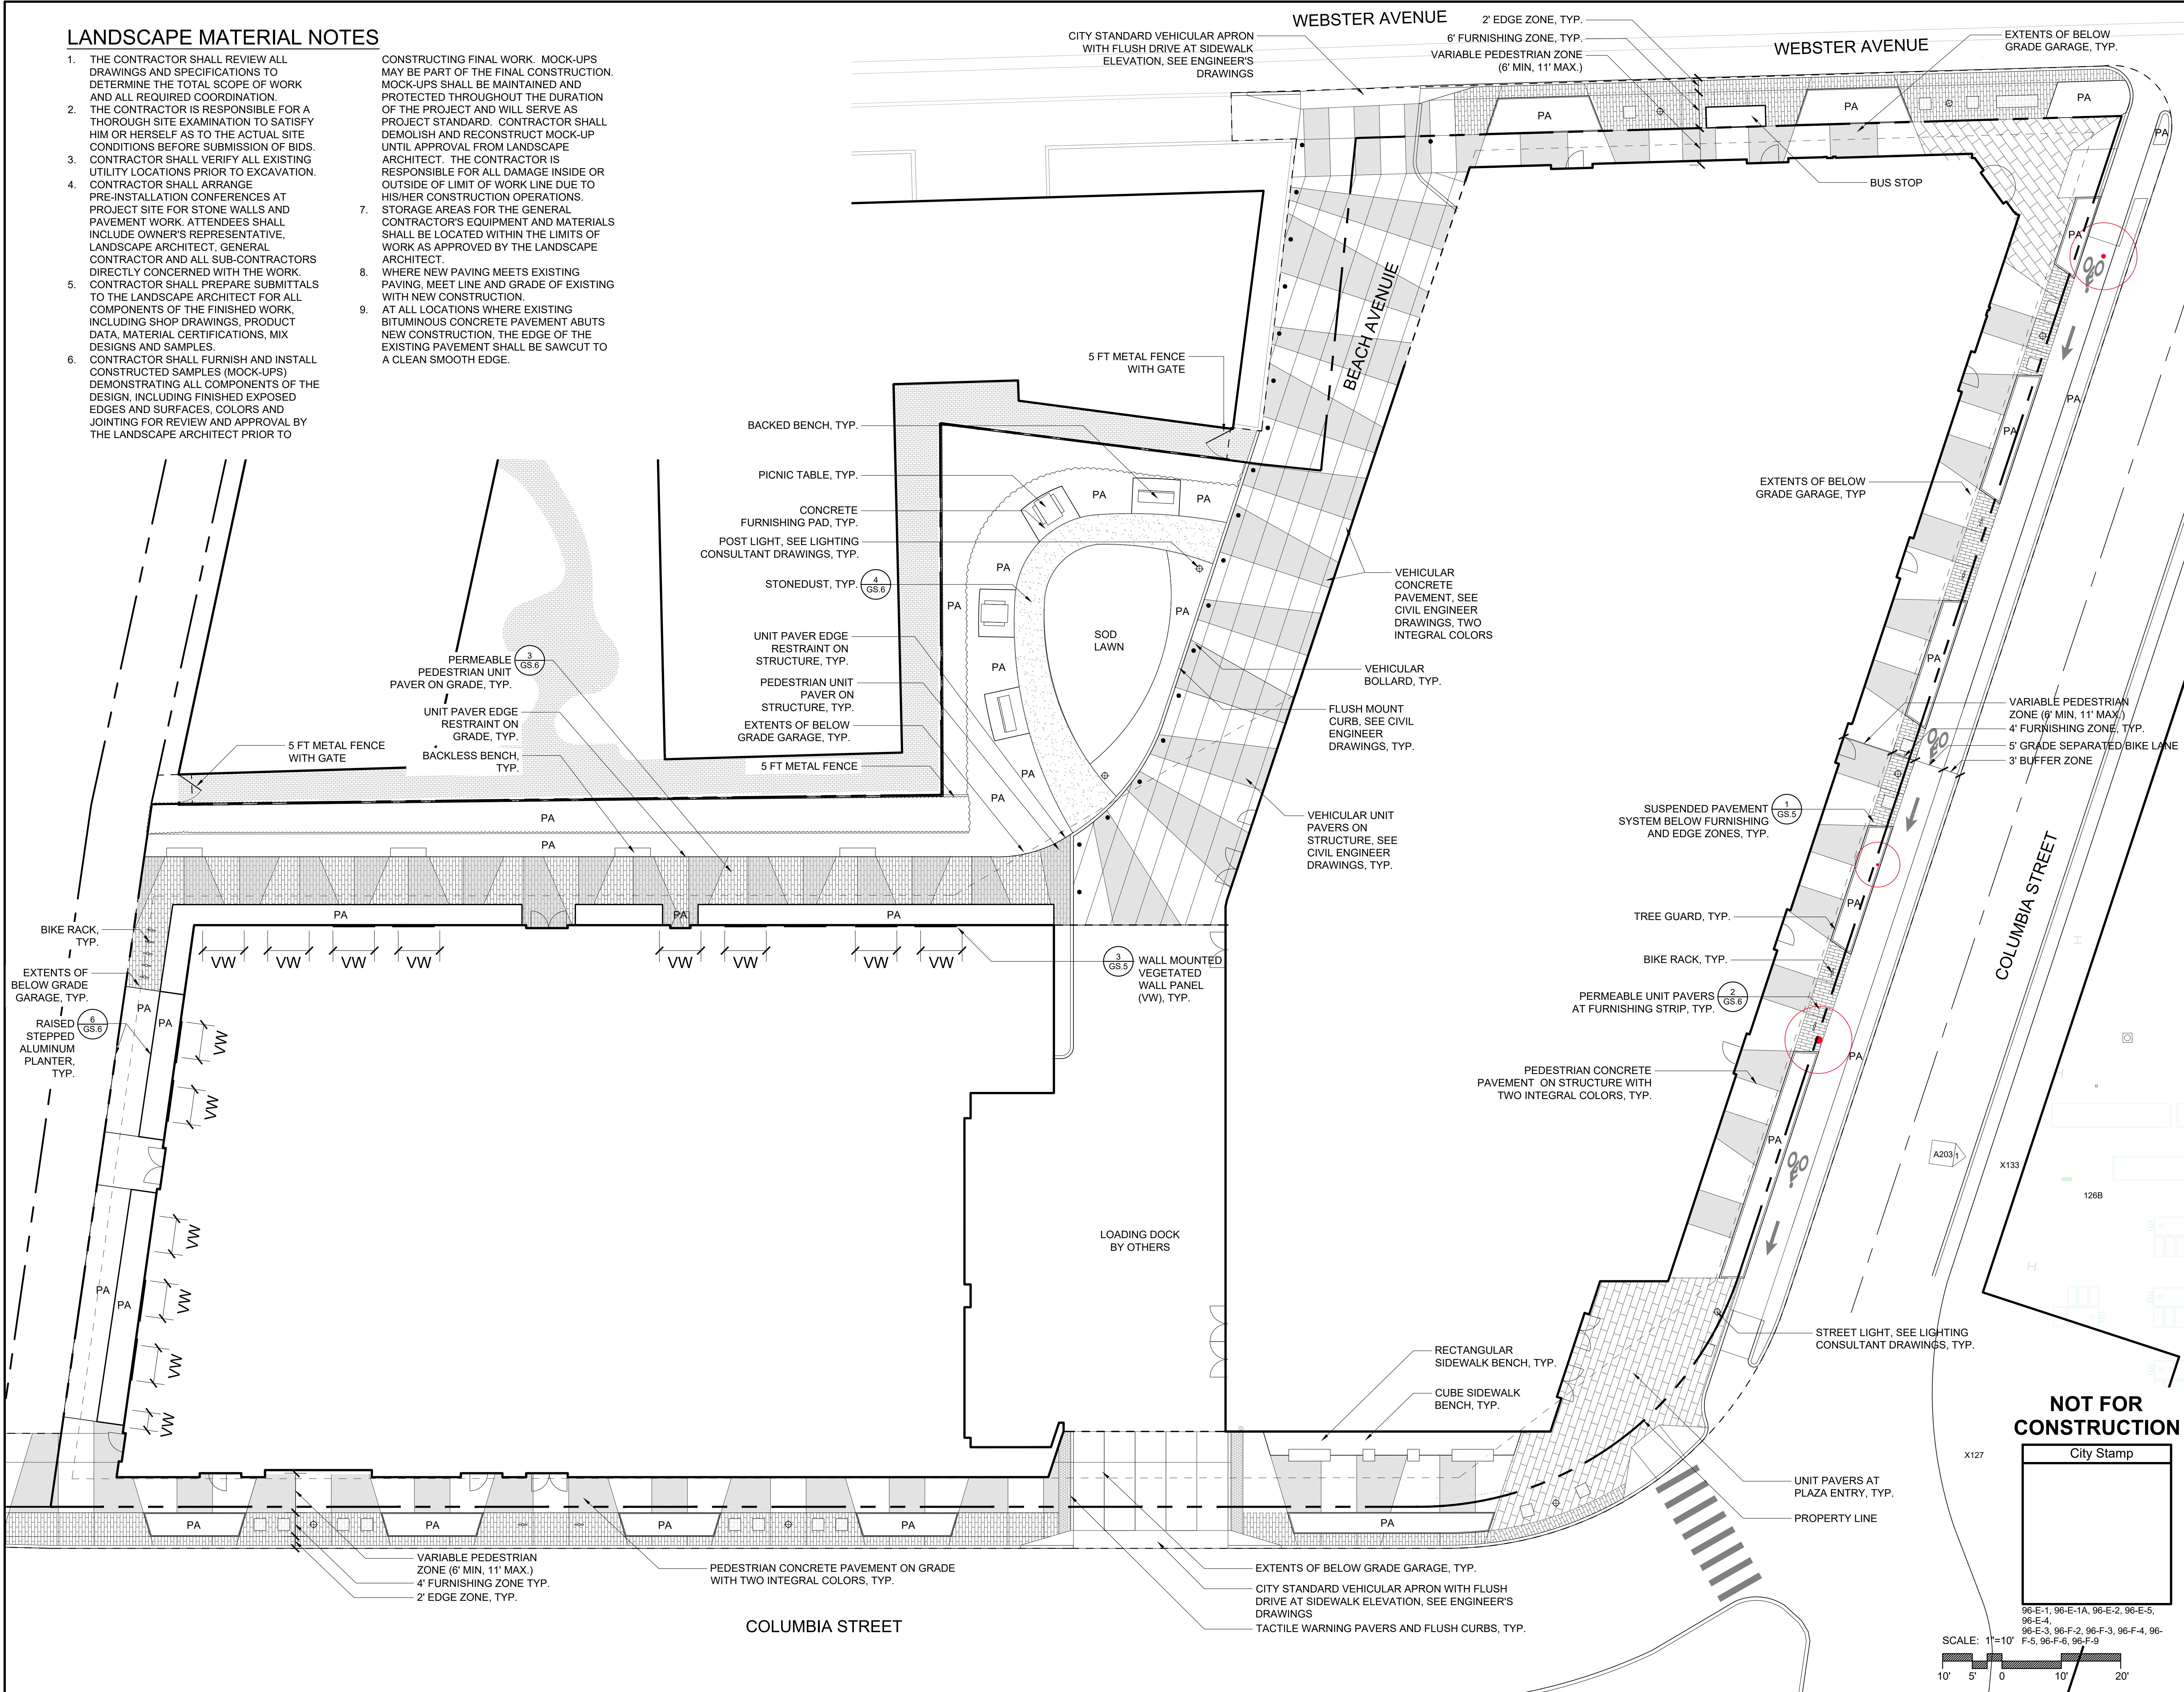

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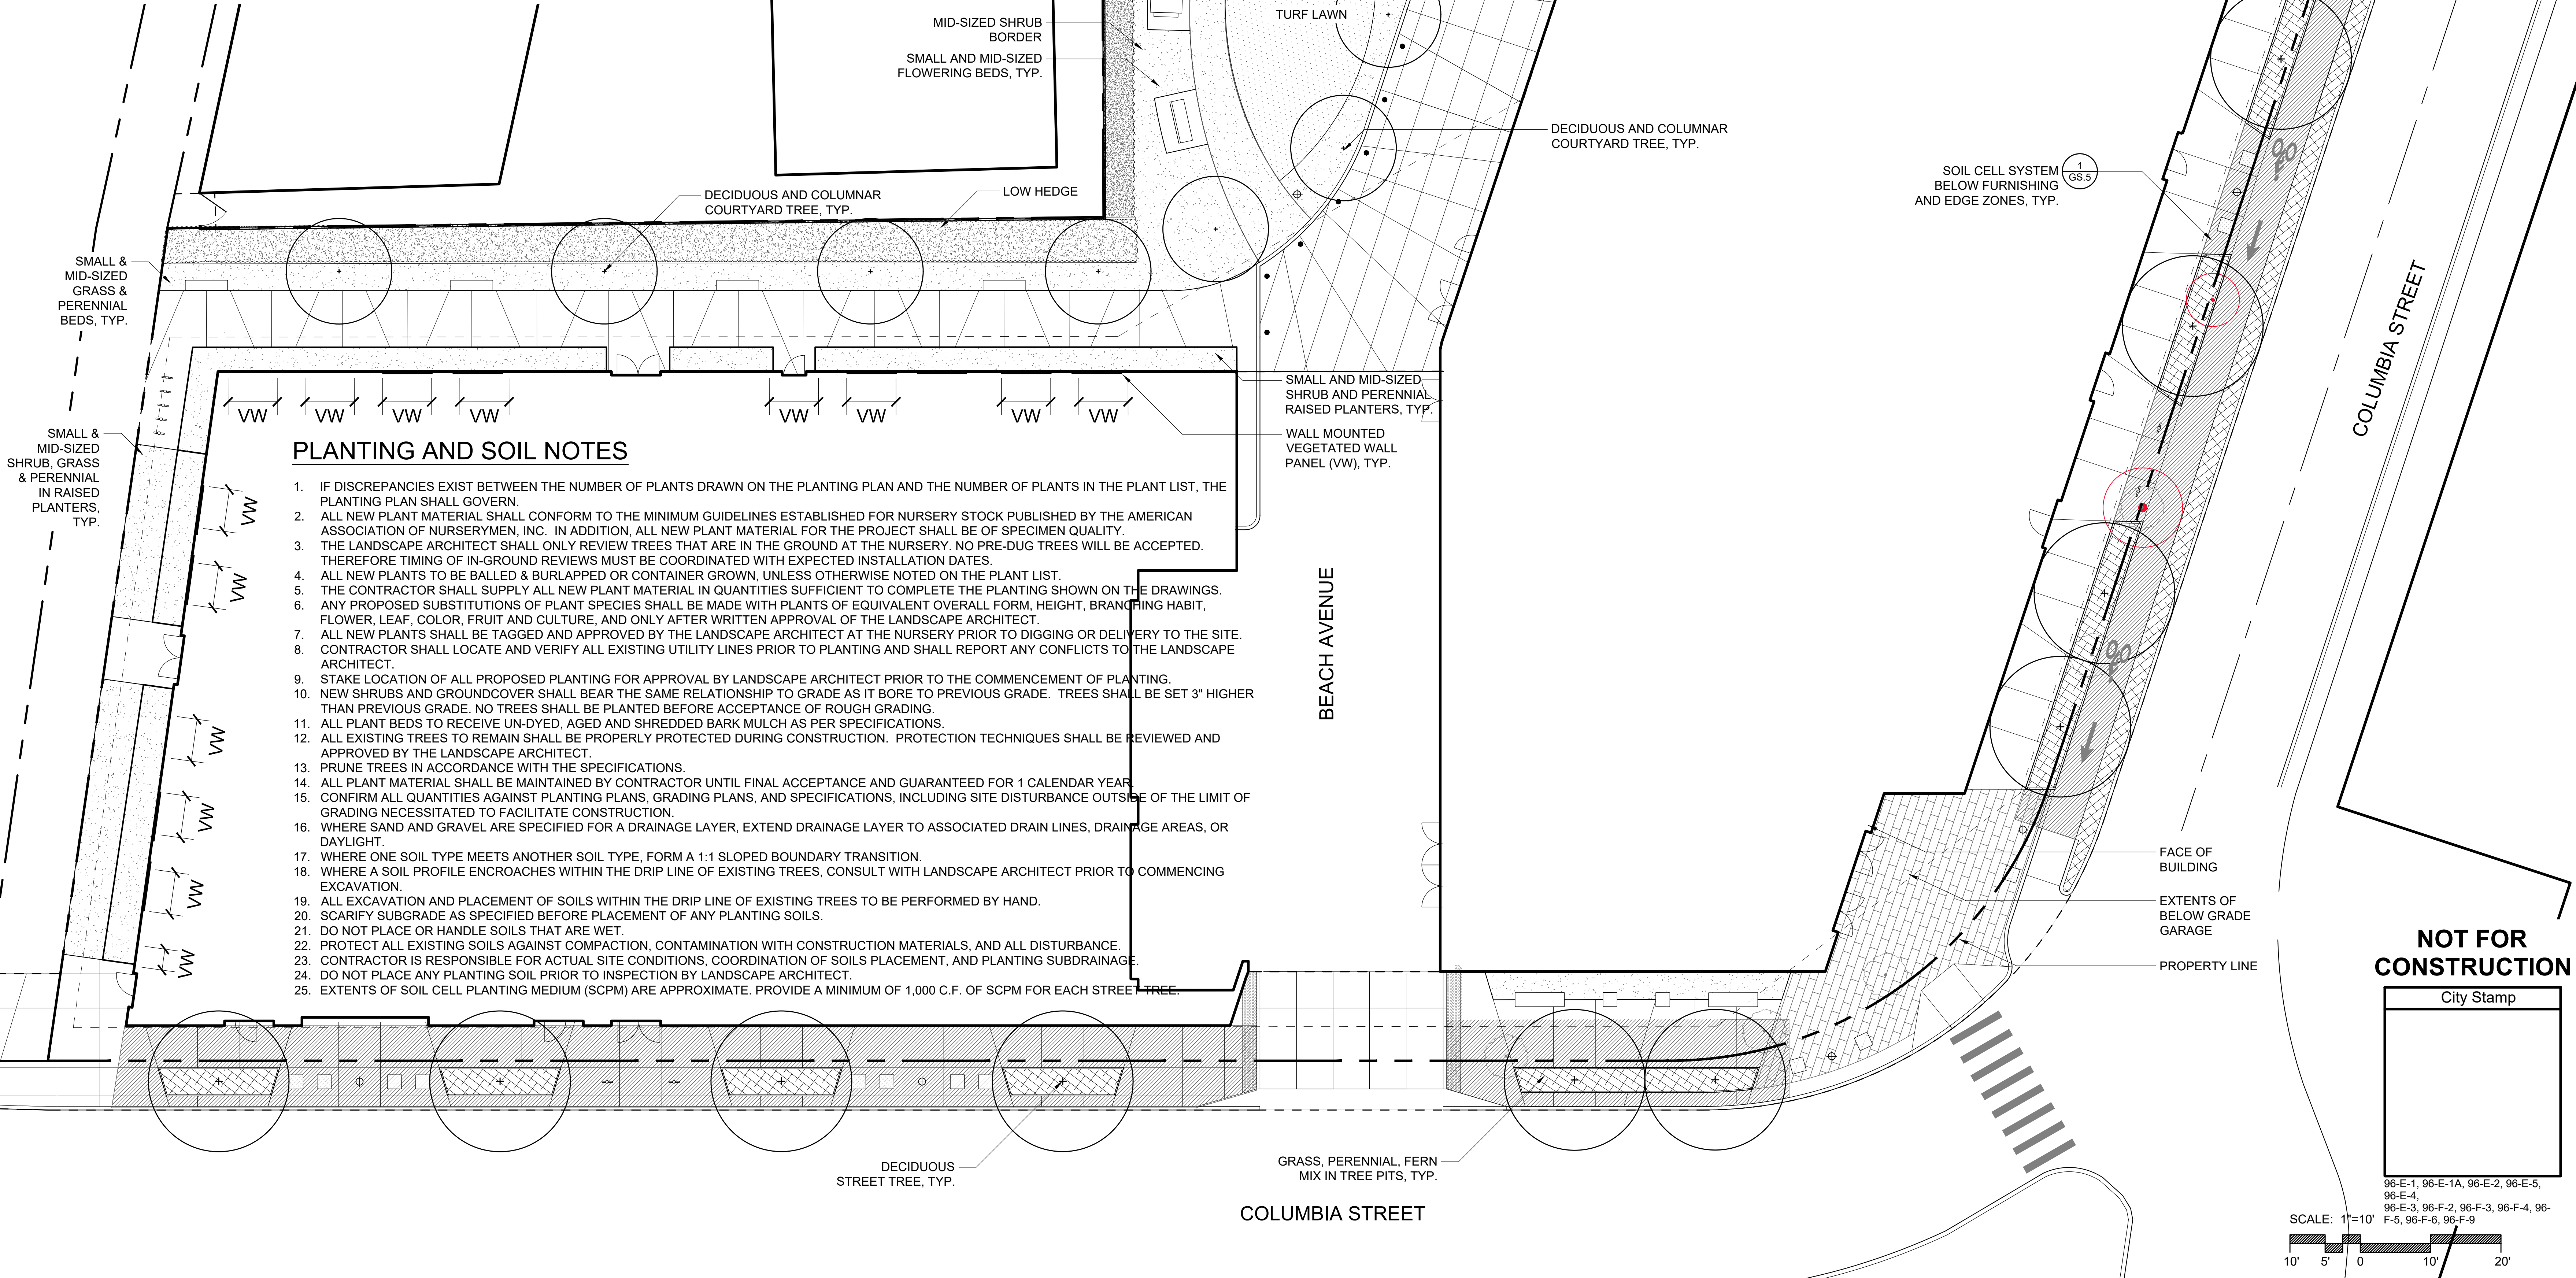
Landscape Layout & Materials Plan

GS.3

PLANTING SCHEDULE

Symb	Qty	Botanical Name	Common Name	Spacing	Gal / B&B	Size Notes/Comments	Green Score Cat.
Deciduous Shade Trees							
CL	2	<i>Celtis laevigata</i>	Sugarberry	40' O.C.	3-3.5" Caliper		Large Tree
QR	6	<i>Quercus rubra</i> var. <i>borealis</i>	Northern Red Oak	40' O.C.	3-3.5" Caliper	Street	Large Tree
UAP	5	<i>Ulmus americana</i> 'Princeton'	American Elm	40' O.C.	3-3.5" Caliper	Street	Large Tree
TA	8	<i>Tilia Americana</i>	American Basswood	AS DRAWN	3-3.5" Caliper	Street	Large Tree
Shrubs							
AMM		<i>Aronia melanocarpa</i> 'Morton'	Iroquois Beauty Black Chokeberry	24" O.C.	#2		Vegetation >= 2' Tall at Maturity
CSA		<i>Cornus sanguinea</i> 'Arctic Sun'	Arctic Sun Dogwood	30" O.C.	#3		Vegetation >= 2' Tall at Maturity
IVR		<i>Ilex verticillata</i> 'Red Sprite'	Red Sprite Dwarf Female Winterberry	36" O.C.	#3		Vegetation >= 2' Tall at Maturity
IVJ		<i>Ilex verticillata</i> 'Jim Dandy'	Jim Dandy Dwarf Male Winterberry	36" O.C.	#3		Vegetation >= 2' Tall at Maturity
TOB	34	<i>Thuja occidentalis</i> 'Brabant'	Nordic Brabant Arborvitae	48" O.C.	B&B	6-7'	Vegetation >= 2' Tall at Maturity
BMJ	111	<i>Buxus microphylla</i> var. <i>japonica</i> 'Winter Gem'	Winter Gem Boxwood	36" O.C.	#3		Vegetation >= 2' Tall at Maturity
RAG		<i>Rhus aromatica</i> 'Gro-low'	Gro-low Sumac	18" o.c.			Vegetation <= 2' Tall at Maturity
Perennials / Grasses							
PVS		<i>Panicum virgatum</i> 'Shenandoah'	Shenandoah Switch Grass	24" O.C.	#2		Vegetation >= 2' Tall at Maturity
SSB		<i>Schizachyrium scoparium</i> 'The Blues'	The Blues Little Bluestem	18" O.C.	#2		Vegetation >= 2' Tall at Maturity
AFF		<i>Athyrium filix-femina</i>	Lady Fern	18" O.C.	#2		Vegetation >= 2' Tall at Maturity
OC		<i>Osmunda cinnamomea</i> L.	Cinnamon Fern	18" O.C.	#2		Vegetation >= 2' Tall at Maturity
MDS		<i>Monarda didyma</i> 'Squaw'	Squaw Beebalm	18" O.C.	#2		Vegetation >= 2' Tall at Maturity
RFG		<i>Rudbeckia fulgida</i> 'Goldsturm'	Goldsturm Black-eyed Susan	18" O.C.	#2		Vegetation >= 2' Tall at Maturity
EP		<i>Echinacea purpurea</i>	Eastern Purple Coneflower	18" O.C.	#2		Vegetation >= 2' Tall at Maturity
VH		<i>Veronica hastata</i>	Blue Vervain	18" O.C.	#1		Vegetation >= 2' Tall at Maturity
AC		<i>Aquilegia canadensis</i>	Eastern Red Columbine	12" O.C.	#1		Vegetation >= 2' Tall at Maturity
DP		<i>Dennstaedtia punctilobula</i>	Hay-scented Fern	12" O.C.	#1		Vegetation <= 2' Tall at Maturity
PTS		<i>Eragrostis spectabilis</i>	Purple Lovegrass	12" O.C.	#1		Vegetation <= 2' Tall at Maturity
CP		<i>Carex pensylvanica</i>	Pennsylvania Sedge	12" O.C.	#1		Vegetation <= 2' Tall at Maturity
LS		<i>Liriope muscari</i>	Lily Turf	12" O.C.	#1		Vegetation <= 2' Tall at Maturity
CVM		<i>Coreopsis verticillata</i> 'Moonbeam'	Moonbeam Coreopsis	18" O.C.	#2		Vegetation <= 2' Tall at Maturity
Vine Mix							
PT		<i>Parthenocissus tricuspidata</i>	Boston Ivy	12" O.C.	#1		Vegetation >= 2' Tall at Maturity
HAP		<i>Hydrangea anomala petiolaris</i>	Climbing Hydrangea	12" O.C.	#1		Vegetation >= 2' Tall at Maturity
CR		<i>Campsis radicans</i>	Trumpet Creeper	12" O.C.	#1		Vegetation >= 2' Tall at Maturity
LH		<i>Lonicera x heckrottii</i>	Honeysuckle	12" O.C.	#1		Vegetation >= 2' Tall at Maturity
PQ		<i>Parthenocissus quinquefolia</i>	Virginia Creeper	12" O.C.	#1		Vegetation >= 2' Tall at Maturity
CJ		<i>Clematis jackmanii</i>	Climbing Clematis	12" O.C.	#1		Vegetation >= 2' Tall at Maturity
Seeded Areas							

* NOTE: PLANTING PLAN IS STILL UNDER DEVELOPMENT. A FINAL PLANTING PLAN WILL BE AVAILABLE DURING CONSTRUCTION DOCUMENTATION, UPON REQUEST.



PLANTING AND SOIL NOTES

- IF DISCREPANCIES EXIST BETWEEN THE NUMBER OF PLANTS DRAWN ON THE PLANTING PLAN AND THE NUMBER OF PLANTS IN THE PLANT LIST, THE PLANTING PLAN SHALL GOVERN.
- ALL NEW PLANT MATERIAL SHALL CONFORM TO THE MINIMUM GUIDELINES ESTABLISHED FOR NURSERY STOCK PUBLISHED BY THE AMERICAN ASSOCIATION OF NURSERYMEN, INC. IN ADDITION, ALL NEW PLANT MATERIAL FOR THE PROJECT SHALL BE OF SPECIMEN QUALITY.
- THE LANDSCAPE ARCHITECT SHALL ONLY REVIEW TREES THAT ARE IN THE GROUND AT THE NURSERY. NO PRE-DUG TREES WILL BE ACCEPTED. THEREFORE TIMING OF IN-GROUND REVIEWS MUST BE COORDINATED WITH EXPECTED INSTALLATION DATES.
- ALL NEW PLANTS TO BE BALLED & BURLAPPED OR CONTAINER GROWN, UNLESS OTHERWISE NOTED ON THE PLANT LIST.
- THE CONTRACTOR SHALL SUPPLY ALL NEW PLANT MATERIAL IN QUANTITIES SUFFICIENT TO COMPLETE THE PLANTING SHOWN ON THE DRAWINGS.
- ANY PROPOSED SUBSTITUTIONS OF PLANT SPECIES SHALL BE MADE WITH PLANTS OF EQUIVALENT OVERALL FORM, HEIGHT, BRANCHING HABIT, FLOWER, LEAF, COLOR, FRUIT AND CULTURE, AND ONLY AFTER WRITTEN APPROVAL OF THE LANDSCAPE ARCHITECT.
- ALL NEW PLANTS SHALL BE TAGGED AND APPROVED BY THE LANDSCAPE ARCHITECT AT THE NURSERY PRIOR TO DIGGING OR DELIVERY TO THE SITE.
- CONTRACTOR SHALL LOCATE AND VERIFY ALL EXISTING UTILITY LINES PRIOR TO PLANTING AND SHALL REPORT ANY CONFLICTS TO THE LANDSCAPE ARCHITECT.
- STAKE LOCATION OF ALL PROPOSED PLANTING FOR APPROVAL BY LANDSCAPE ARCHITECT PRIOR TO THE COMMENCEMENT OF PLANTING.
- NEW SHRUBS AND GROUND COVER SHALL BEAR THE SAME RELATIONSHIP TO GRADE AS IT BORE TO PREVIOUS GRADE. TREES SHALL BE SET 3" HIGHER THAN PREVIOUS GRADE. NO TREES SHALL BE PLANTED BEFORE ACCEPTANCE OF ROUGH GRADING.
- ALL PLANT BEDS TO RECEIVE UN-DYED, AGED AND SHREDDED BARK MULCH AS PER SPECIFICATIONS.
- ALL EXISTING TREES TO REMAIN SHALL BE PROPERLY PROTECTED DURING CONSTRUCTION. PROTECTION TECHNIQUES SHALL BE REVIEWED AND APPROVED BY THE LANDSCAPE ARCHITECT.
- PRUNE TREES IN ACCORDANCE WITH THE SPECIFICATIONS.
- ALL PLANT MATERIAL SHALL BE MAINTAINED BY CONTRACTOR UNTIL FINAL ACCEPTANCE AND GUARANTEED FOR 1 CALENDAR YEAR.
- CONFIRM ALL QUANTITIES AGAINST PLANTING PLANS, GRADING PLANS, AND SPECIFICATIONS, INCLUDING SITE DISTURBANCE OUTSIDE OF THE LIMIT OF GRADING NECESSITATED TO FACILITATE CONSTRUCTION.
- WHERE SAND AND GRAVEL ARE SPECIFIED FOR A DRAINAGE LAYER, EXTEND DRAINAGE LAYER TO ASSOCIATED DRAIN LINES, DRAINAGE AREAS, OR DAYLIGHT.
- WHERE ONE SOIL TYPE MEETS ANOTHER SOIL TYPE, FORM A 1:1 SLOPED BOUNDARY TRANSITION.
- WHERE A SOIL PROFILE ENROACHES WITHIN THE DRIP LINE OF EXISTING TREES, CONSULT WITH LANDSCAPE ARCHITECT PRIOR TO COMMENCING EXCAVATION.
- ALL EXCAVATION AND PLACEMENT OF SOILS WITHIN THE DRIP LINE OF EXISTING TREES TO BE PERFORMED BY HAND.
- SCARIFY SUBGRADE AS SPECIFIED BEFORE PLACEMENT OF ANY PLANTING SOILS.
- DO NOT PLACE OR HANDLE SOILS THAT ARE WET.
- PROTECT ALL EXISTING SOILS AGAINST COMPACTION, CONTAMINATION WITH CONSTRUCTION MATERIALS, AND ALL DISTURBANCE.
- CONTRACTOR IS RESPONSIBLE FOR ACTUAL SITE CONDITIONS, COORDINATION OF SOILS PLACEMENT, AND PLANTING SUBDRAINAGE.
- DO NOT PLACE ANY PLANTING SOIL PRIOR TO INSPECTION BY LANDSCAPE ARCHITECT.
- EXTENTS OF SOIL CELL PLANTING MEDIUM (SCPM) ARE APPROXIMATE. PROVIDE A MINIMUM OF 1,000 C.F. OF SCPM FOR EACH STREET TREE.



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SPECIFICATIONS

KALIN ASSOCIATES

1121 Washington Street
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617-964-5477

SEAL / SIGNATURE

PROJECT:

Boynton Gateway
495 Columbia Street
Somerville, MA 02143

REVISIONS:

No. Date Description
1 12/15/21 PSUF Responses

SUBMISSIONS:

Date Issued For:
10/18/21 Somerville Development Review

SCALE 1" = 10'-0"

DATE ISSUED 10/18/21

PROJECT NO 5081

DRAWN BY NV




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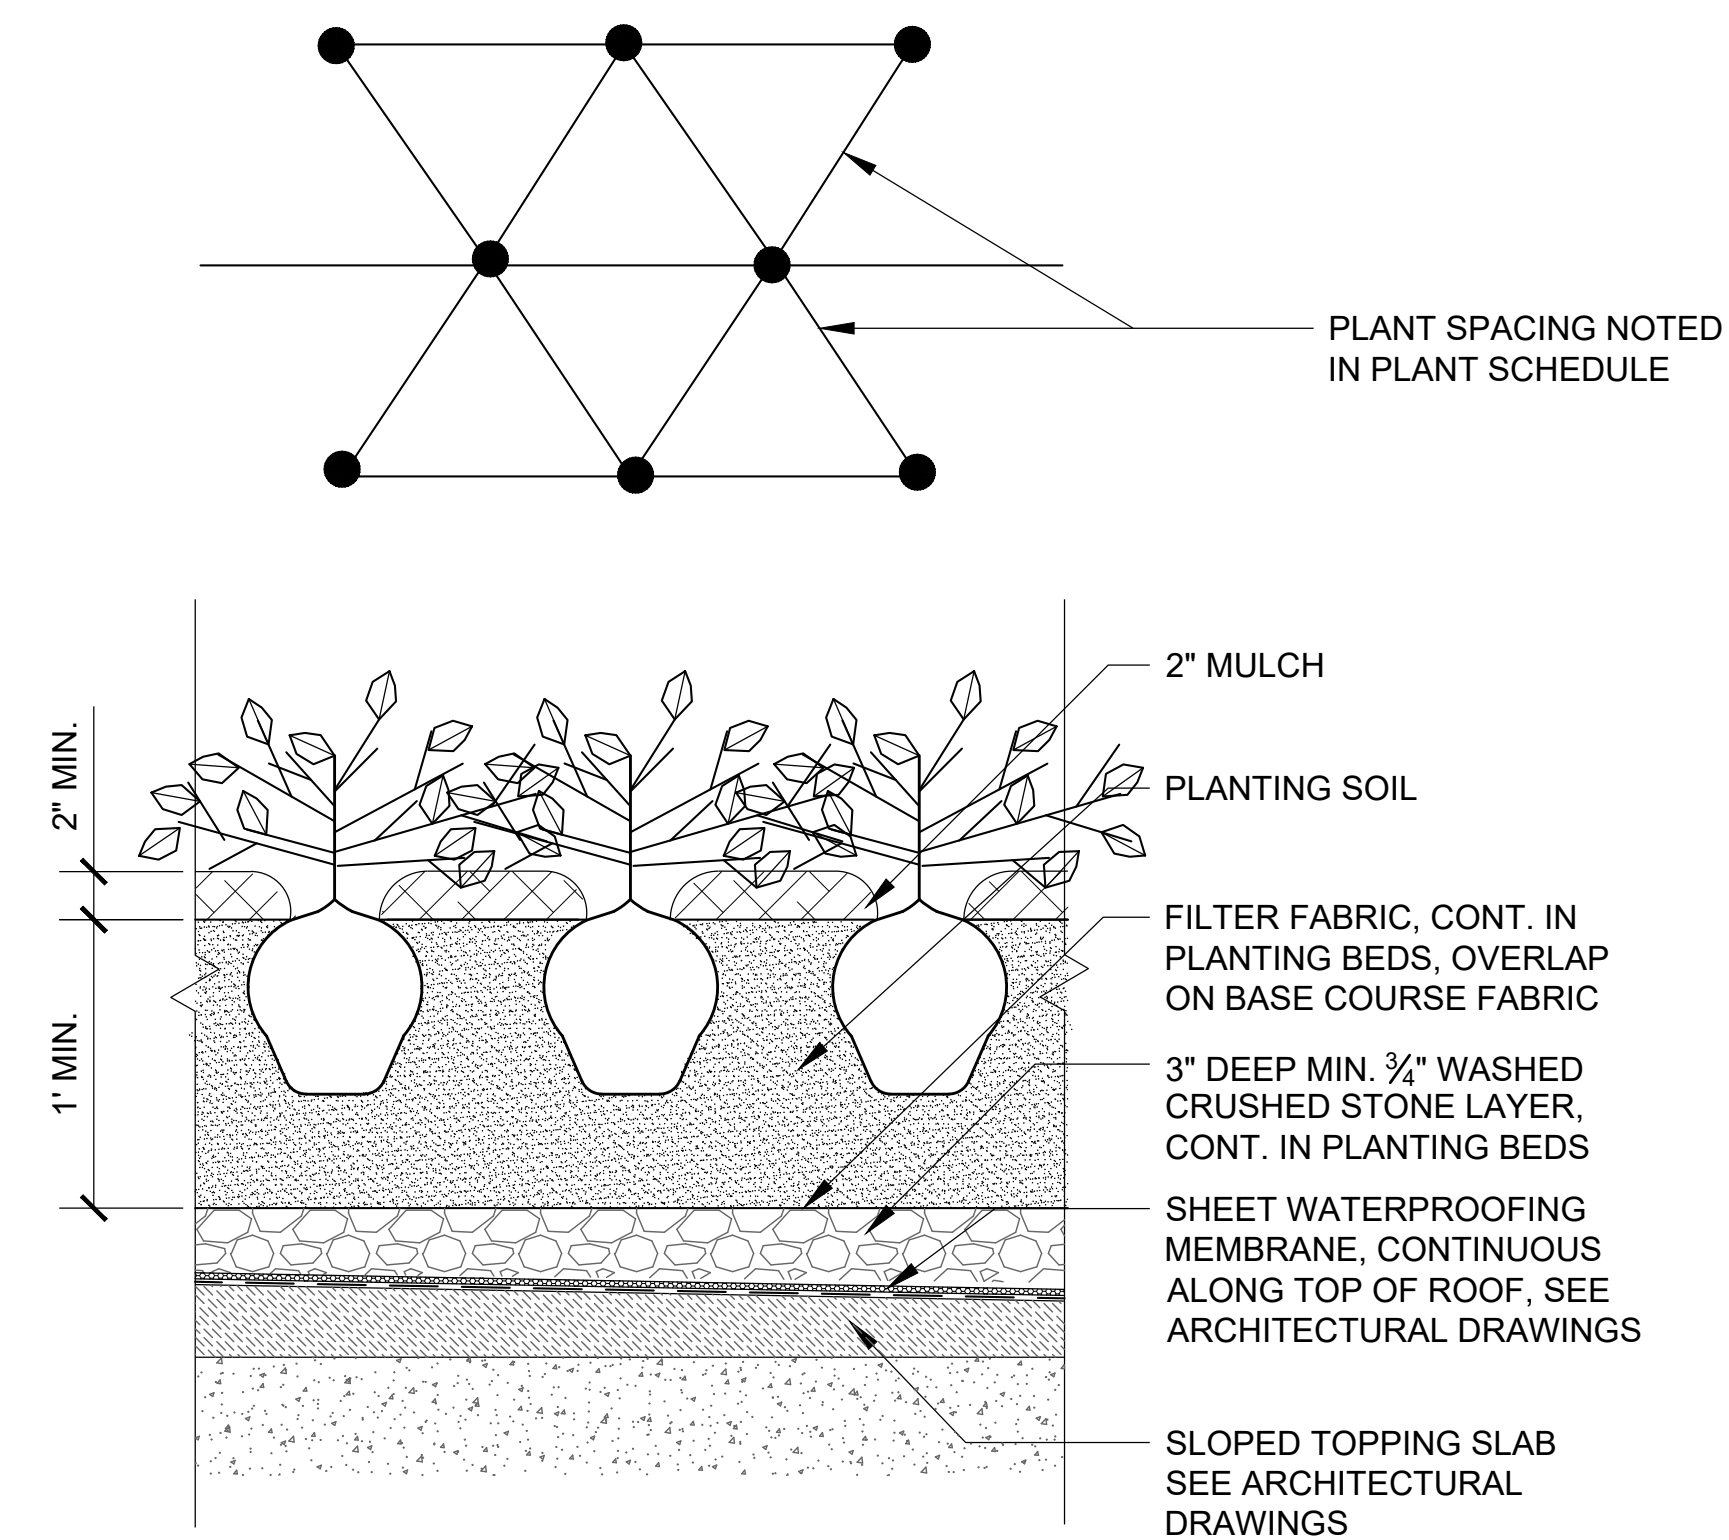
SHEET TITLE:

Landscape

Planting Plan

GS.4



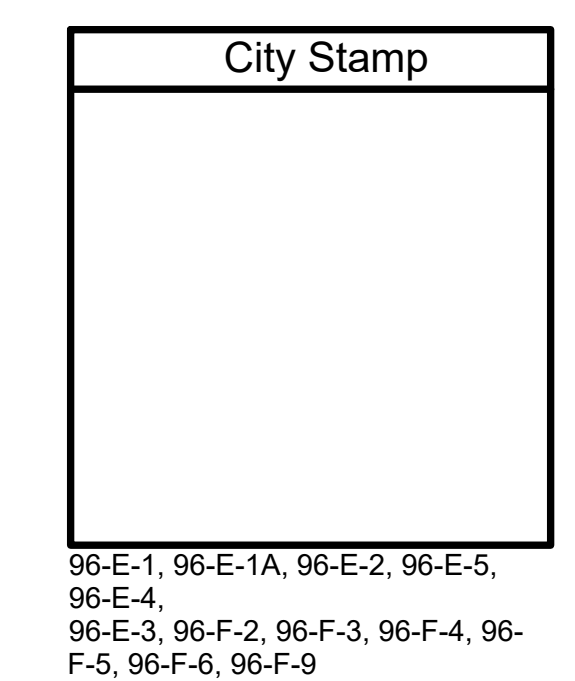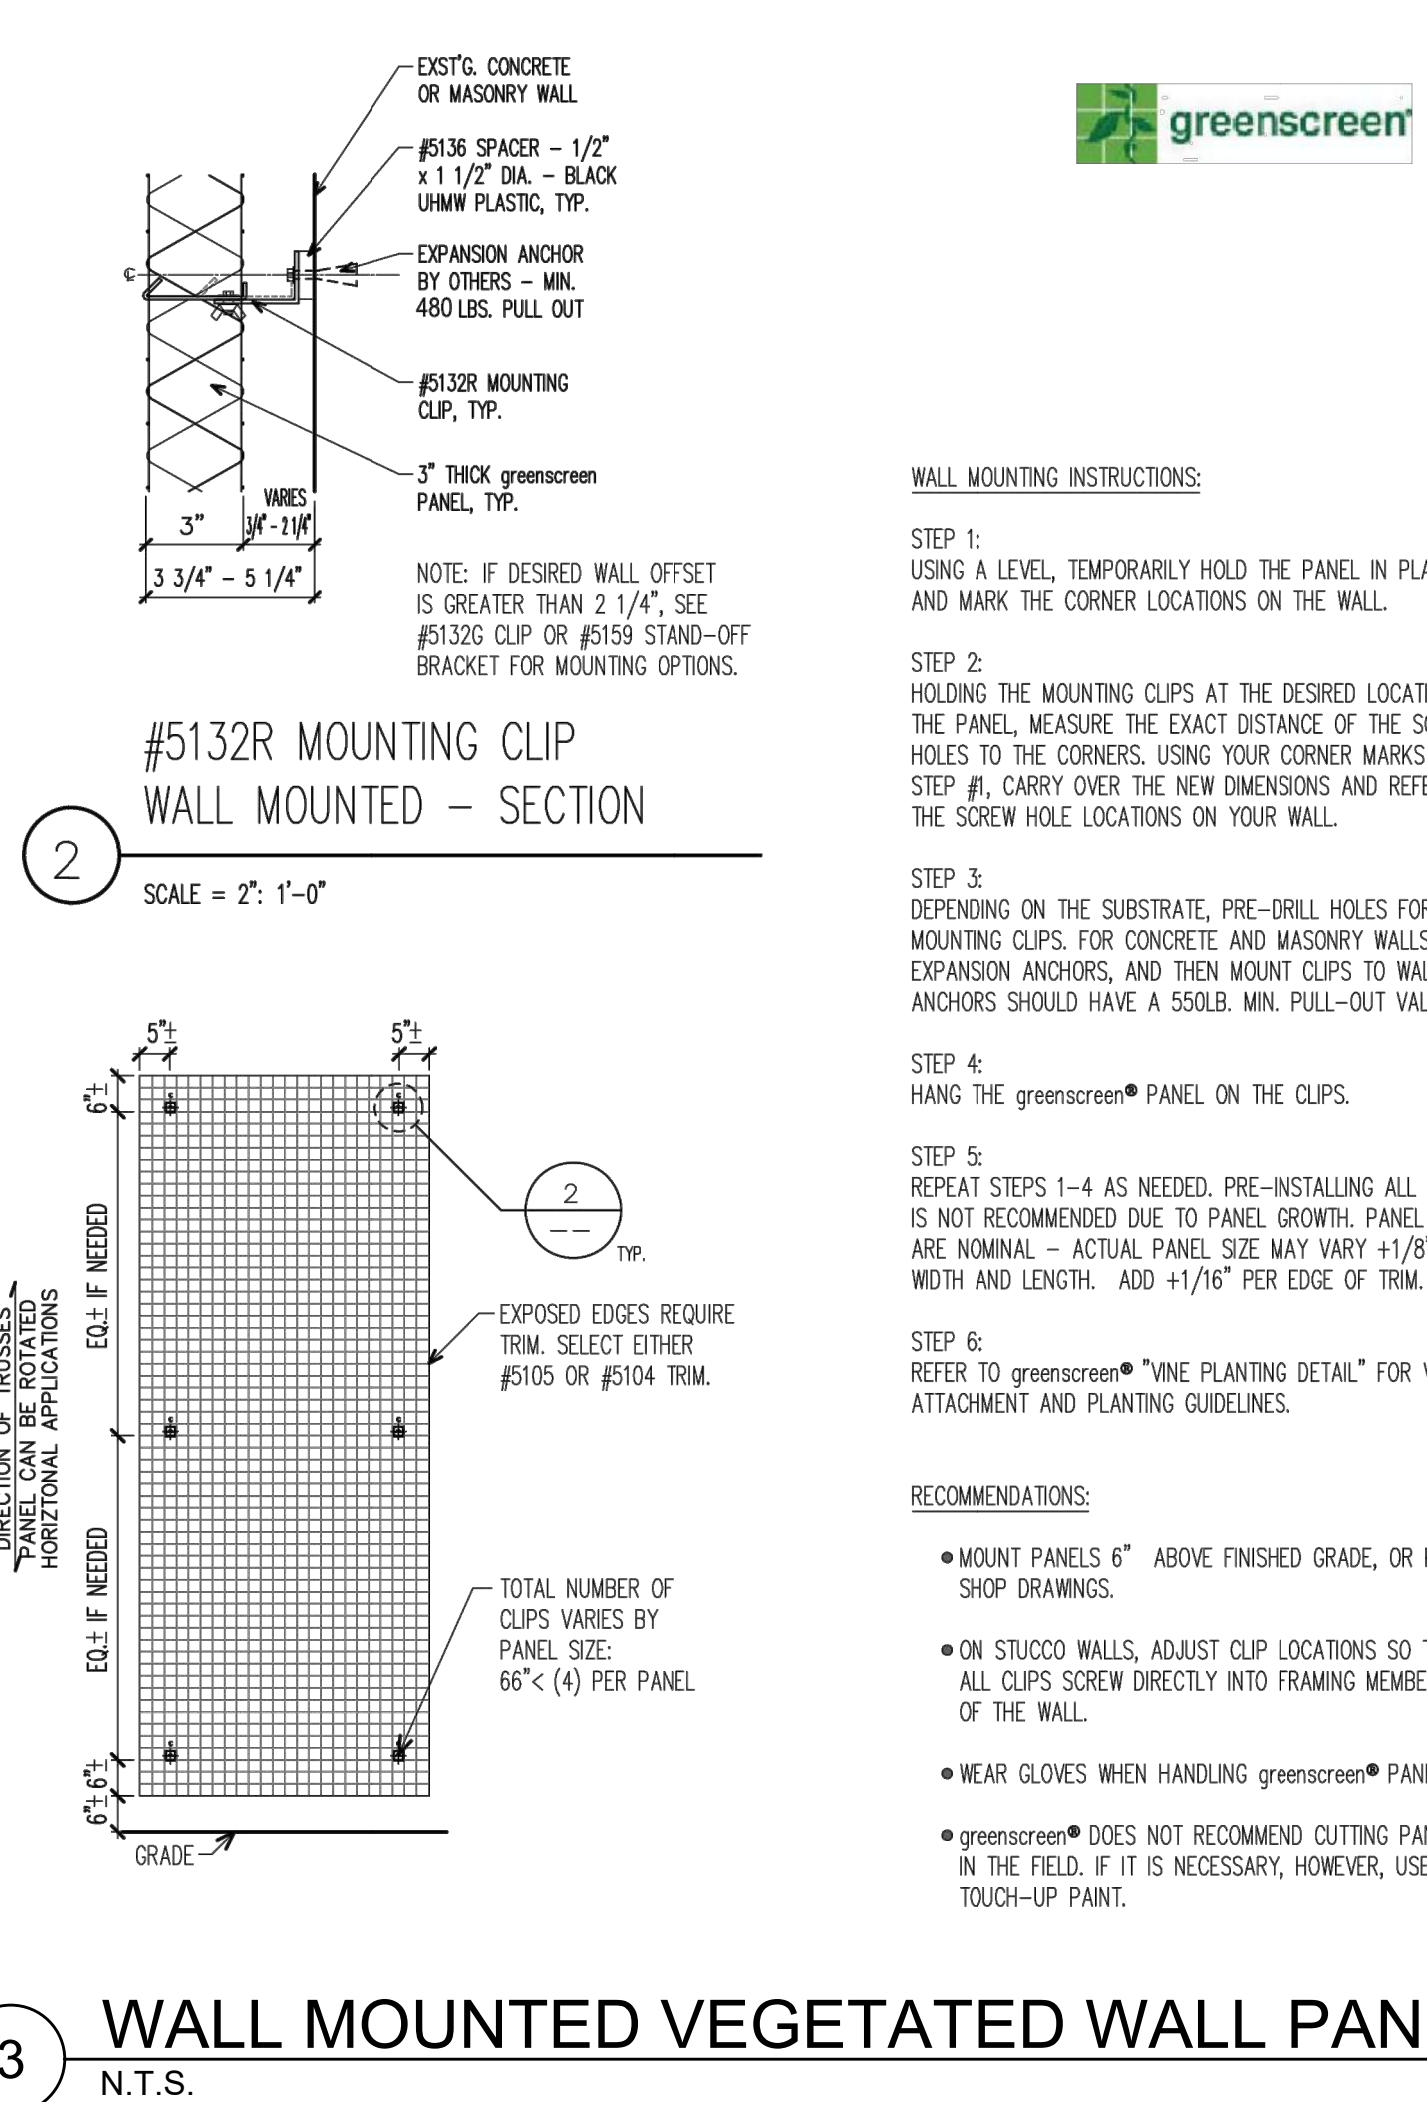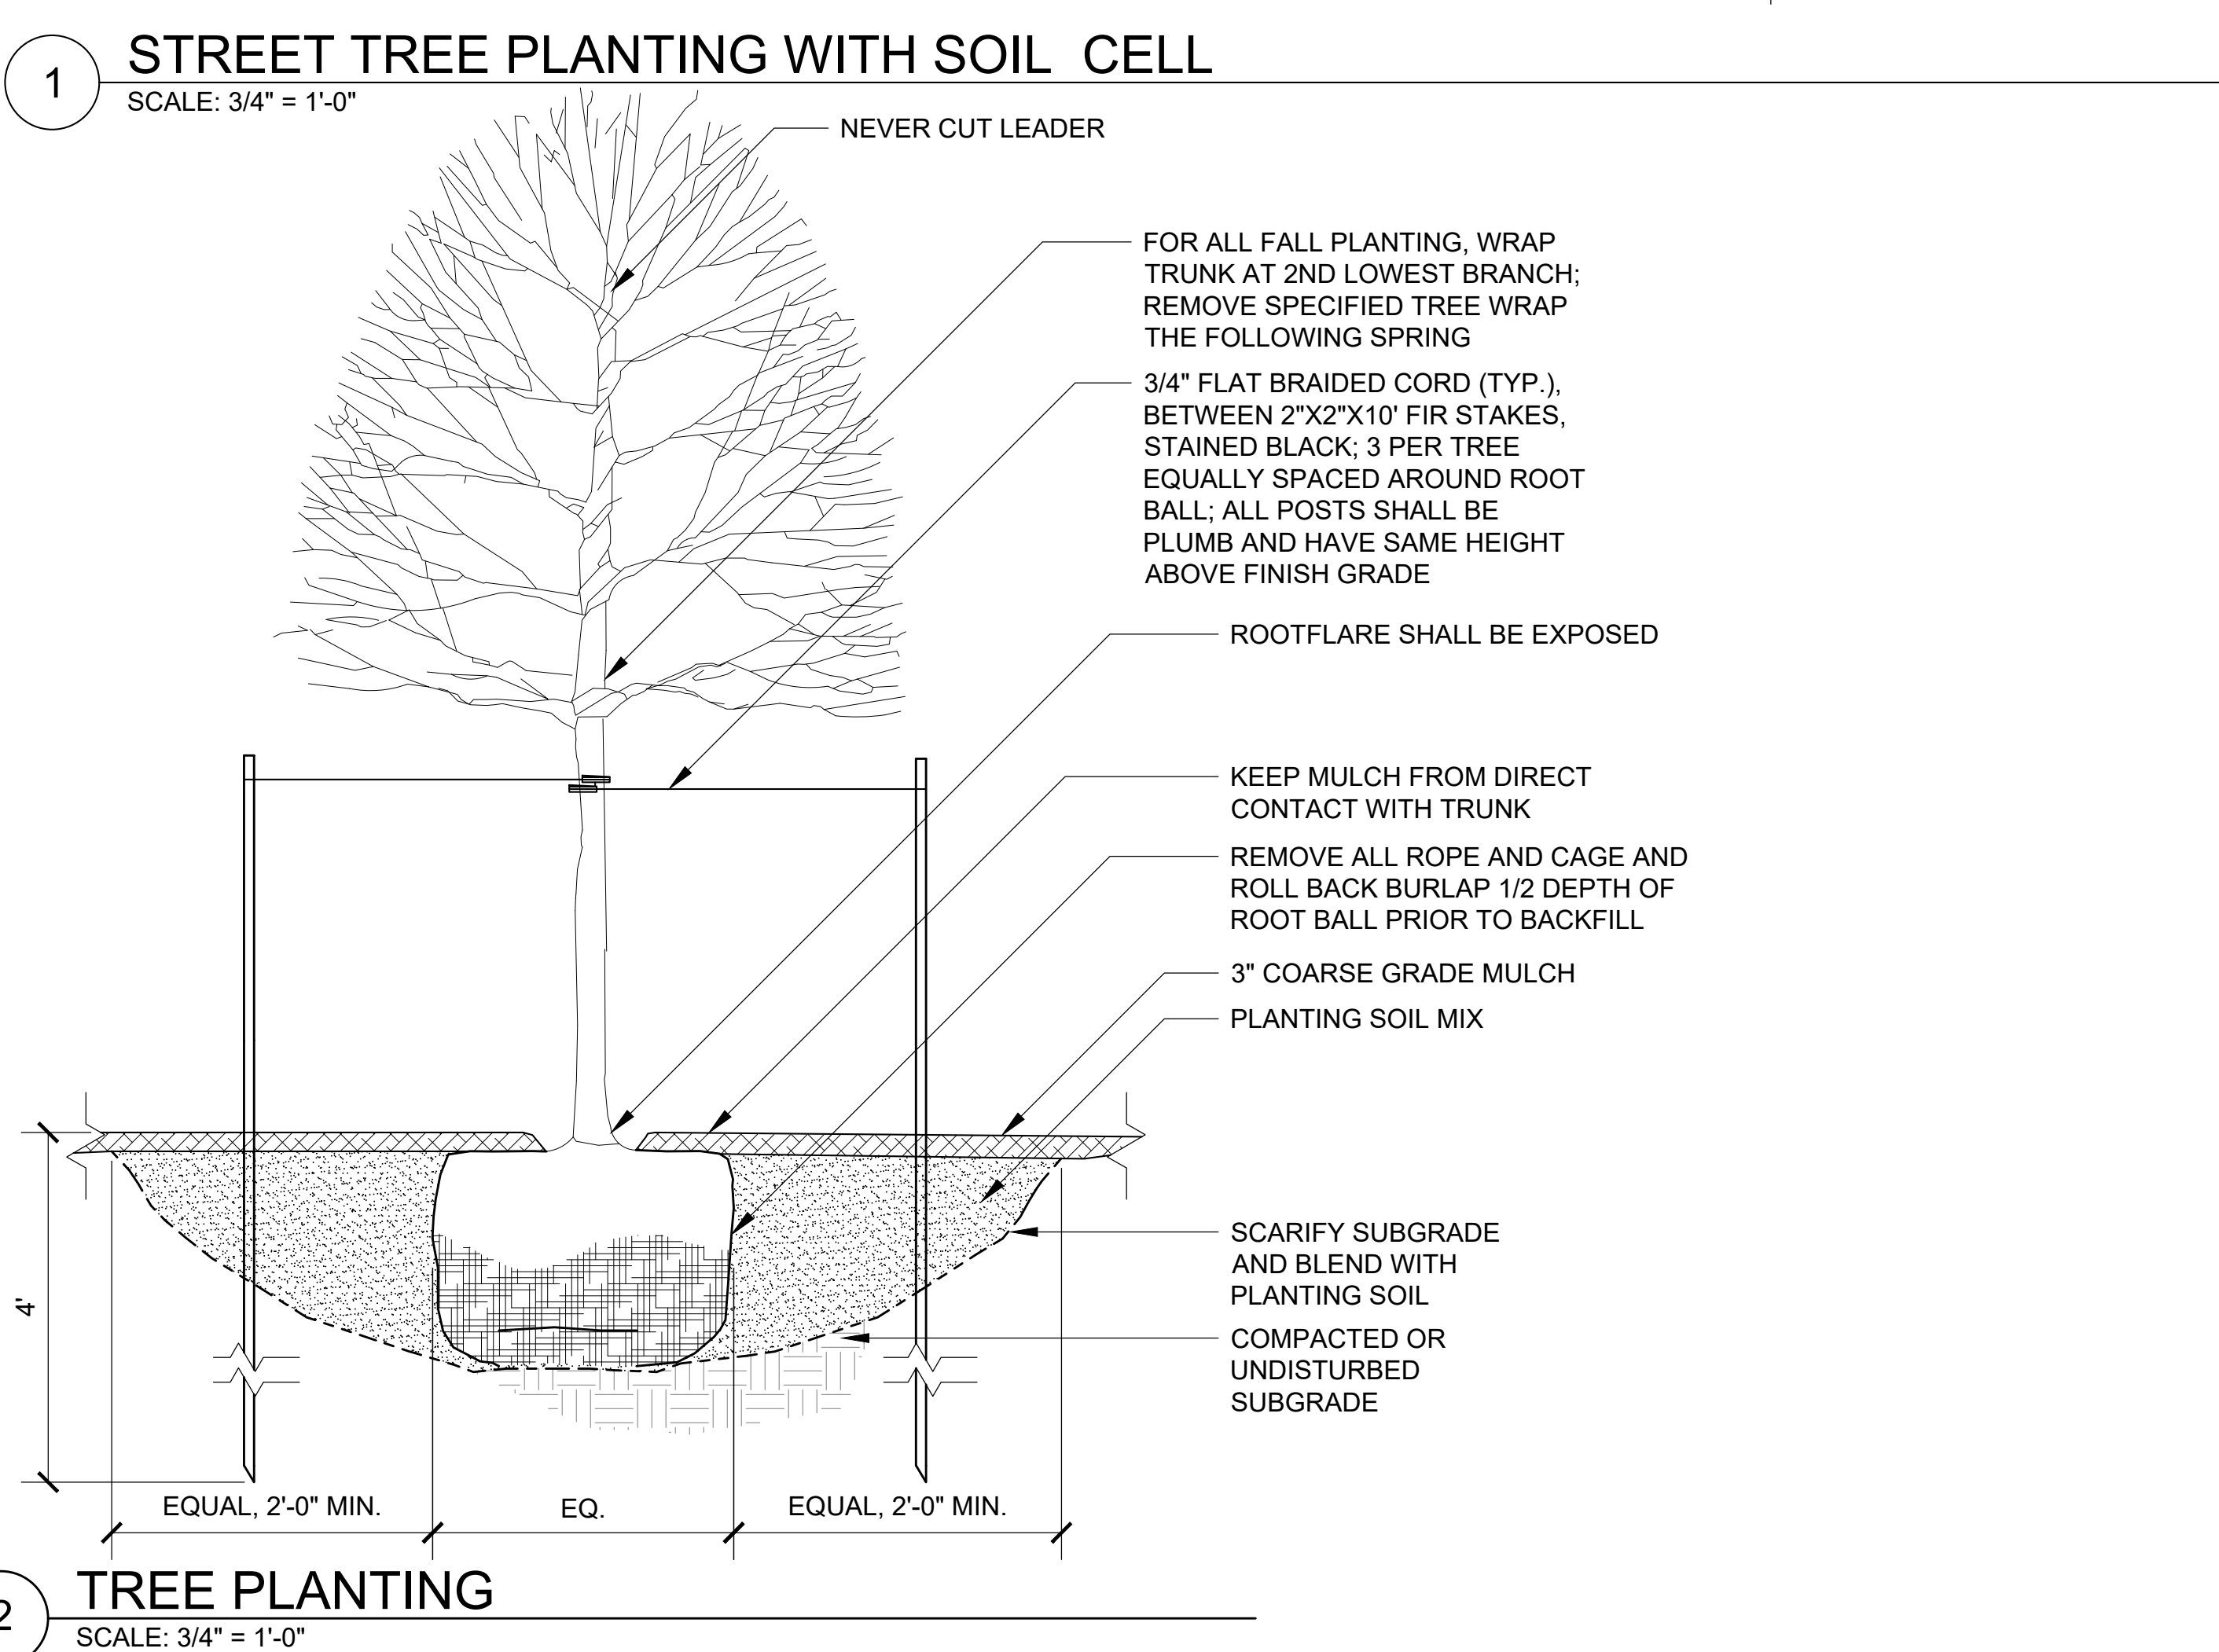


1 PLANTING OVER STRUCTURE
SCALE: 1-1/2" = 1'-0"


PAVERS SHALL BE EQUAL TO ECO-PROMENADE PERMEABLE PAVER AS MANUFACTURED BY UNILOCK, LOCAL REPRESENTATIVE DANIEL NEVIACKAS, MOBILE: 508-341-4306, WWW.UNILOCK.COM.

COLORS: BLEND OF THREE COLORS:
A. WINTER MARVEL (APPROX. 40%)
B. GRENATA WHITE (APPROX. 40%)
C. FRENCH GRAY (APPROX. 20%)


FINISHES: UMBRIANO
EDGE: BEVELED
SIZE: 8" X 24" X 4" NOM WITH SPACER LUGS

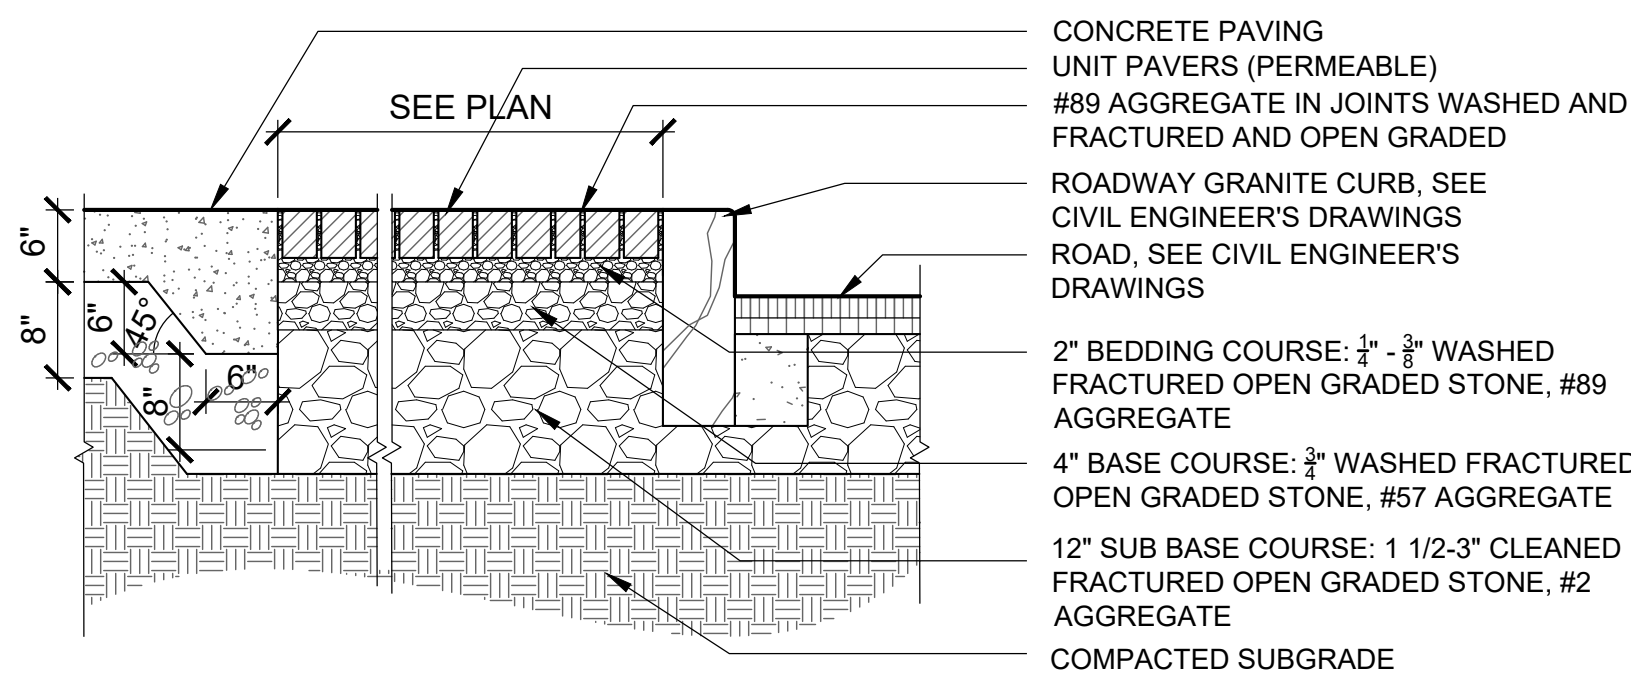


2 PERMEABLE UNIT PAVERS AT FURNISHING STRIP
SCALE: 3/4" = 1'-0"

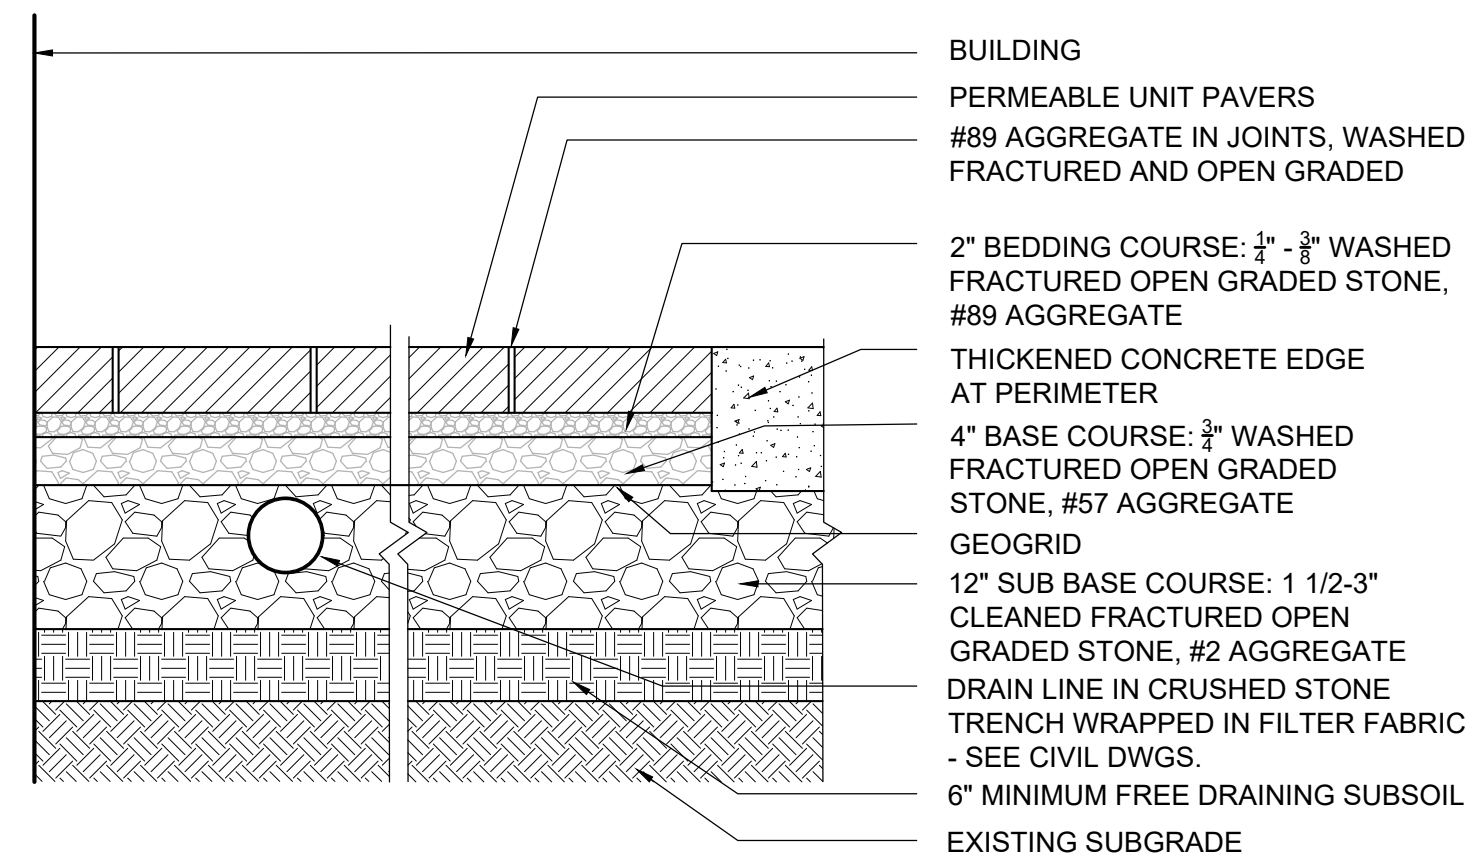


3 PERMEABLE UNIT PAVER - PEDESTRIAN
SCALE: 3/4" = 1'-0"

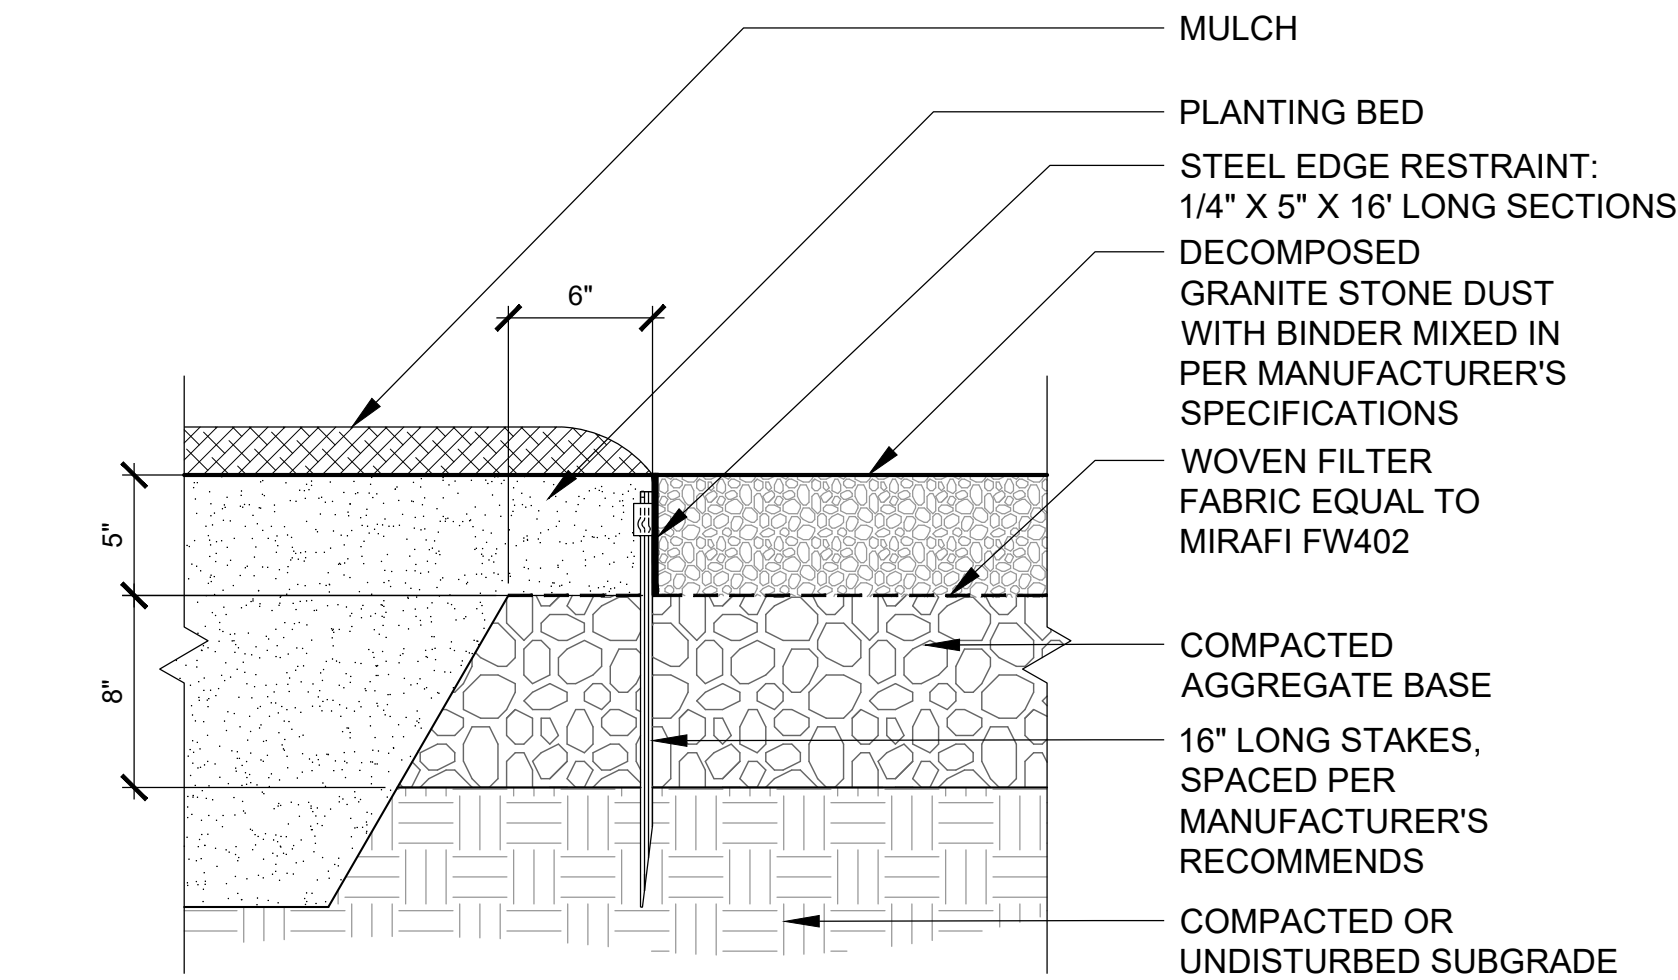


4 STONE DUST SURFACING AT GRADE
SCALE: 1-1/2" = 1'-0"

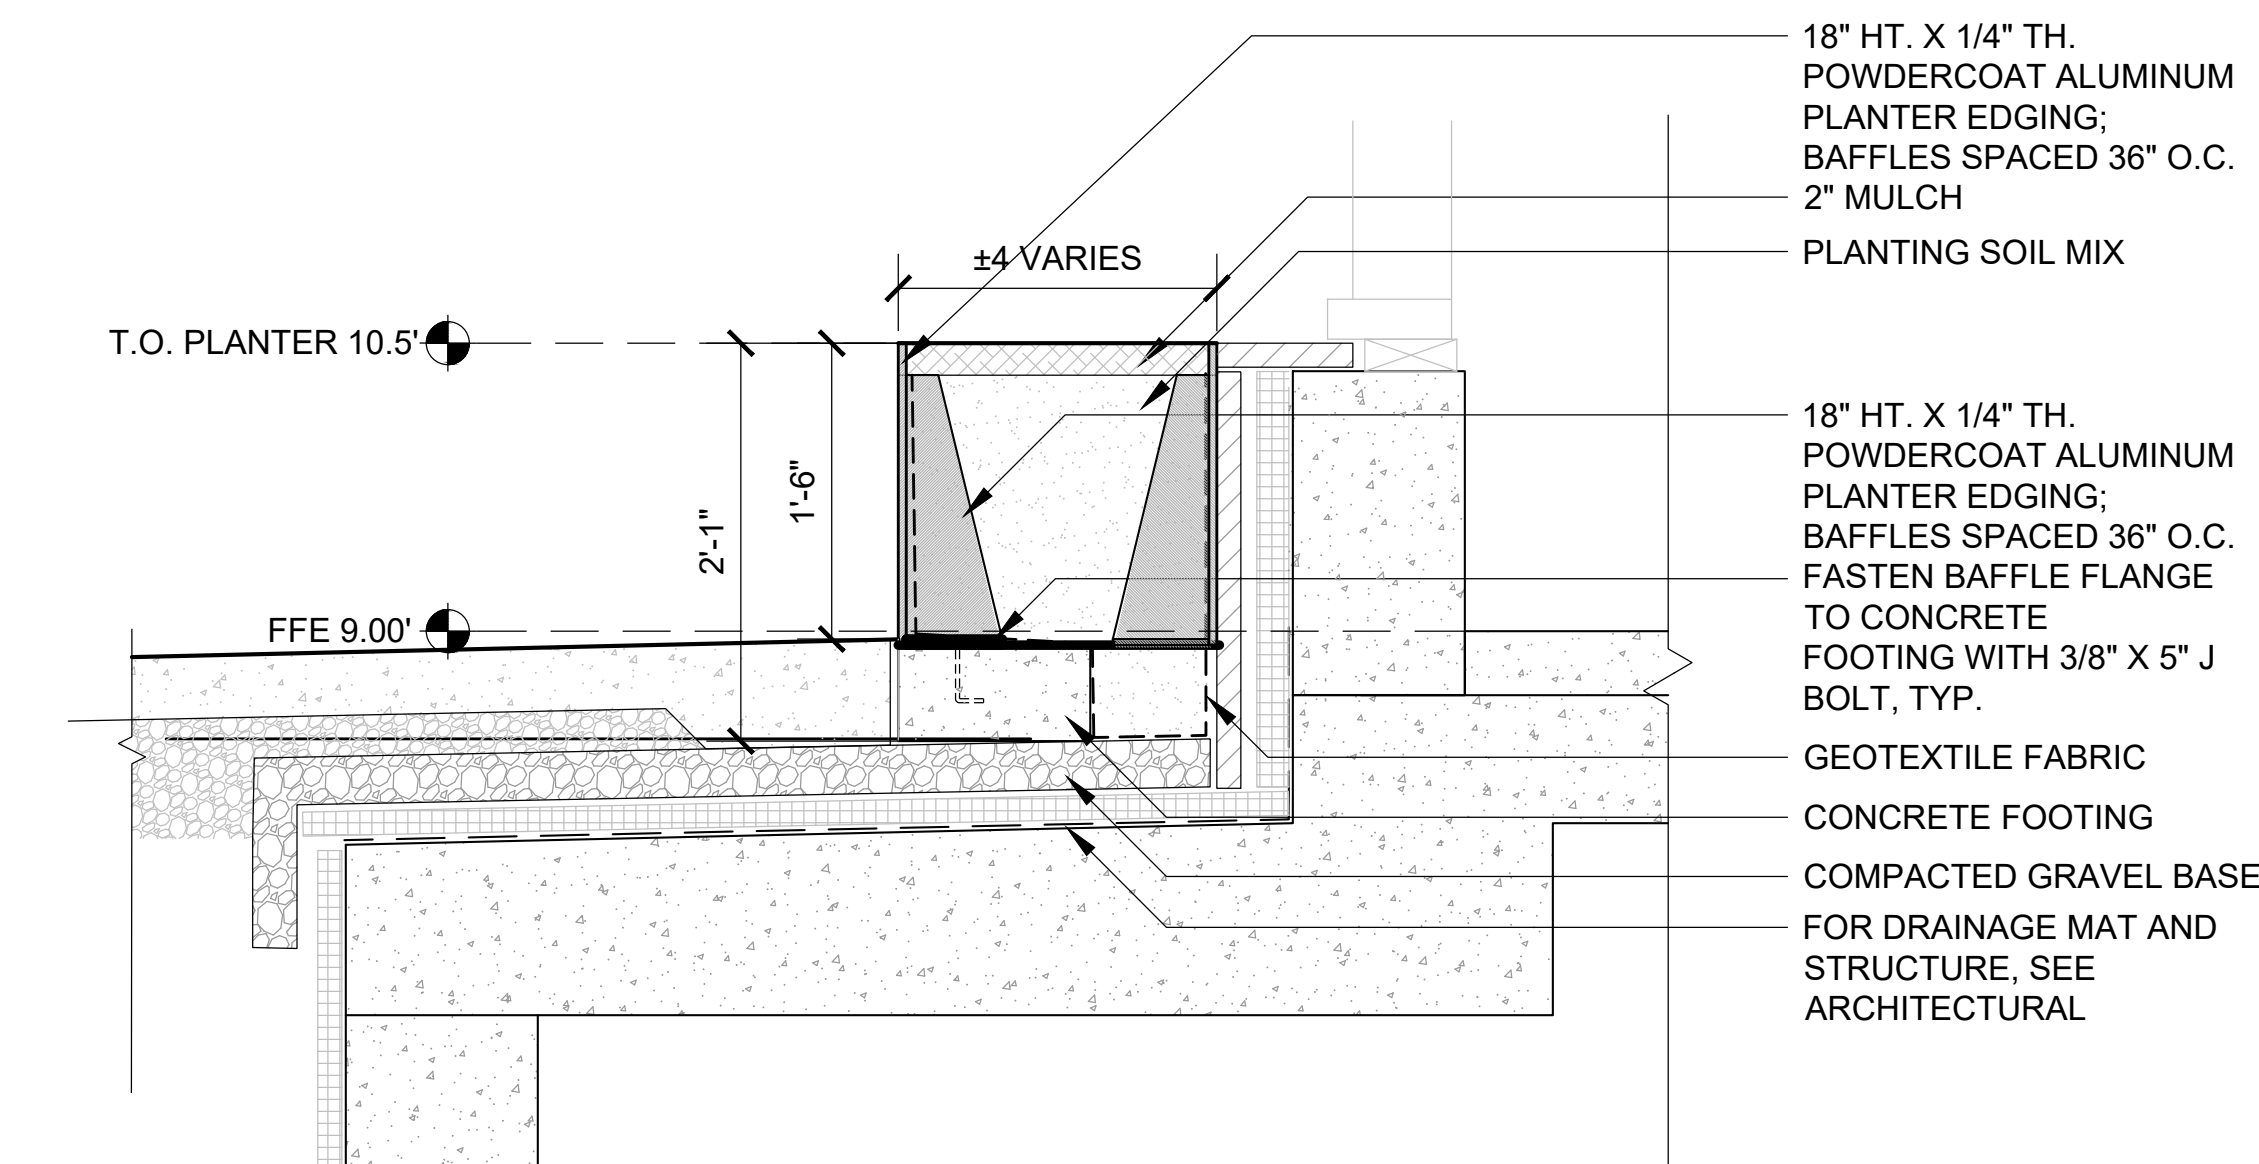


5 RAISED ALUMINUM PLANTER ON STRUCTURE
SCALE: 1" = 1'-0"

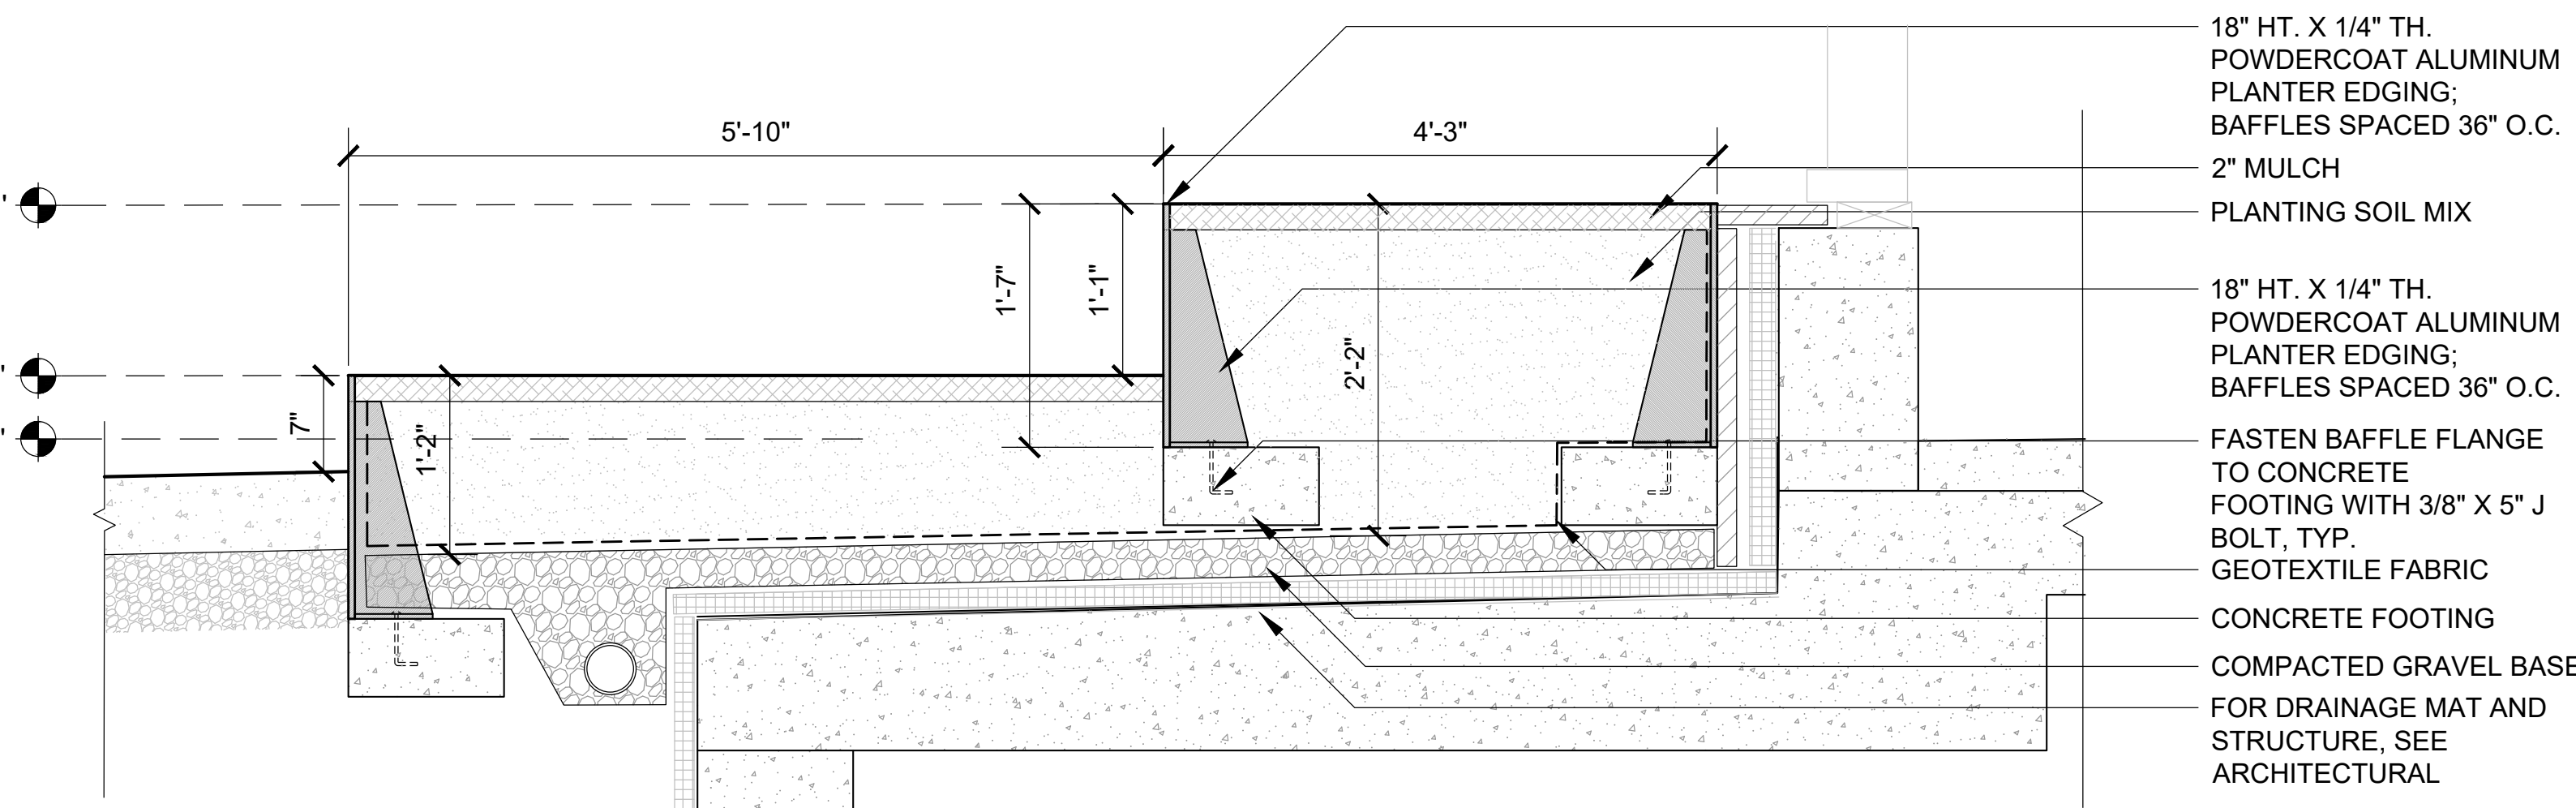


6 RAISED STEPPED ALUMINUM PLANTER ON STRUCTURE
SCALE: 1" = 1'-0"

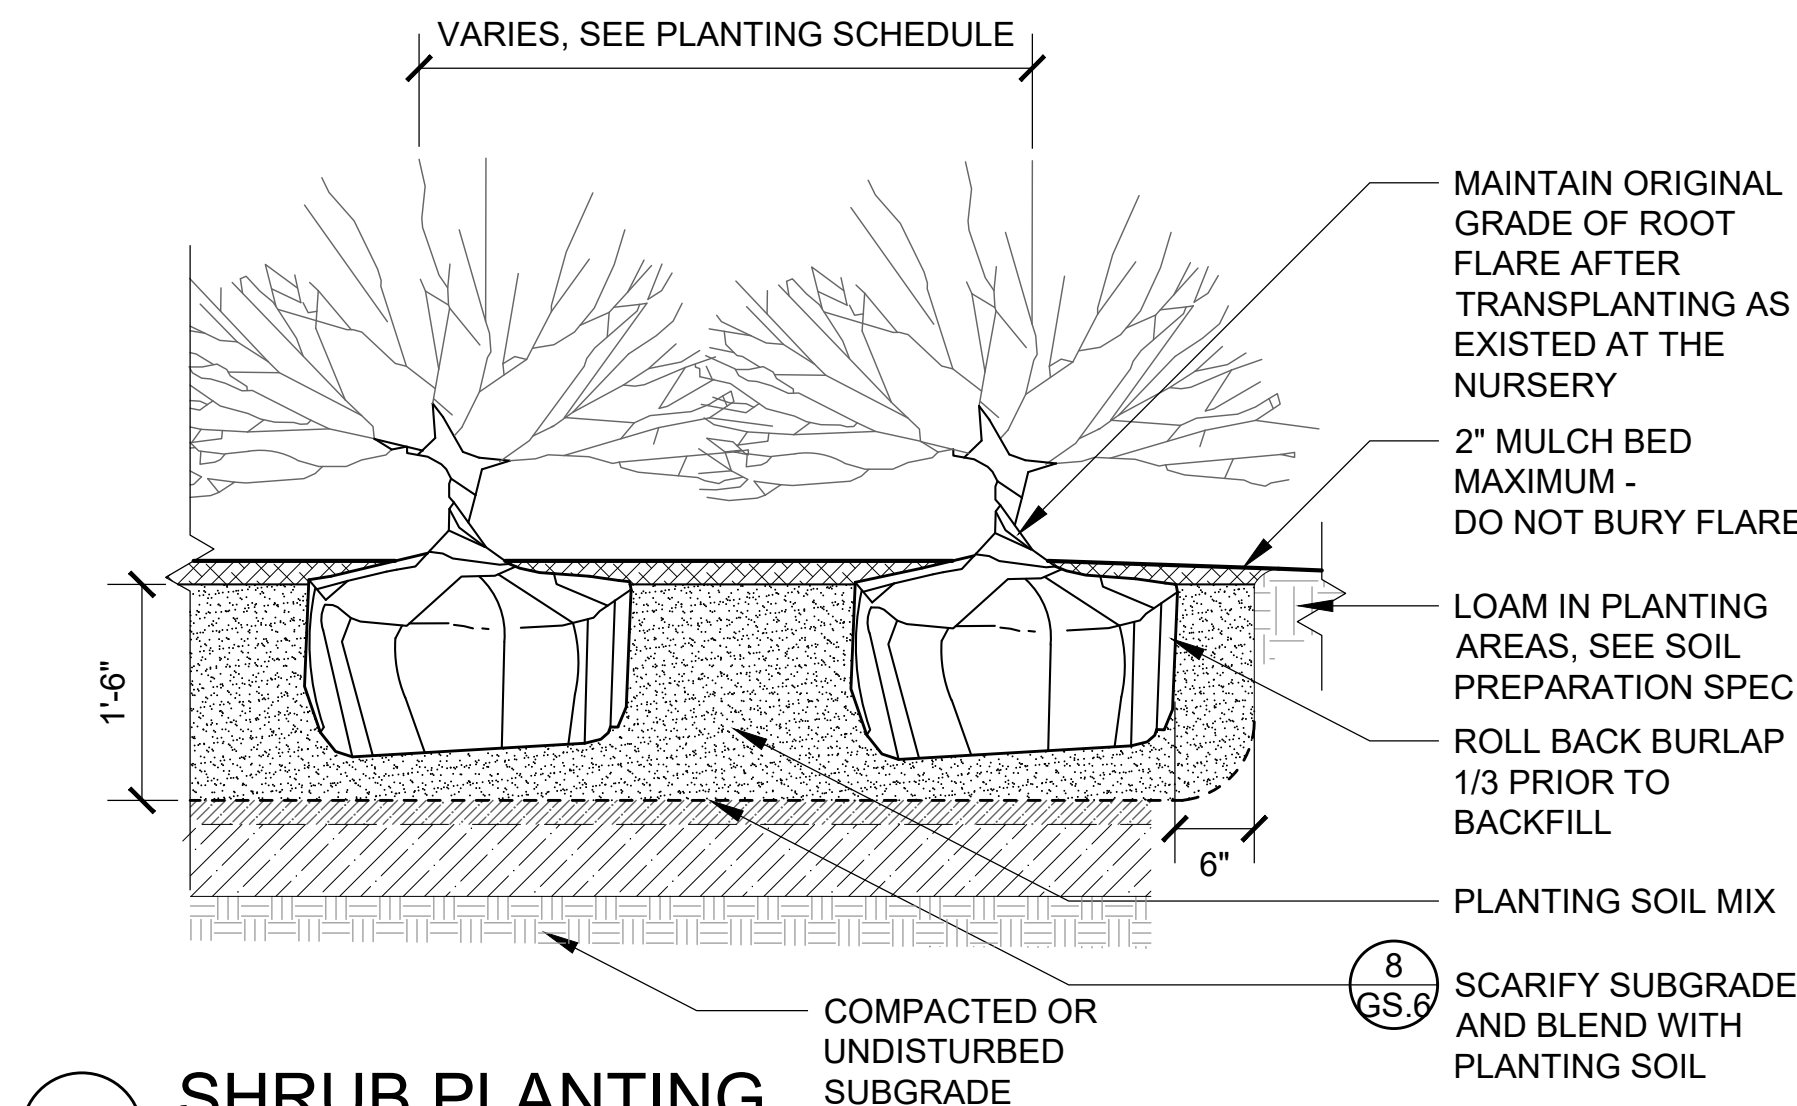

7 SHRUB PLANTING
SCALE: 3/4" = 1'-0"

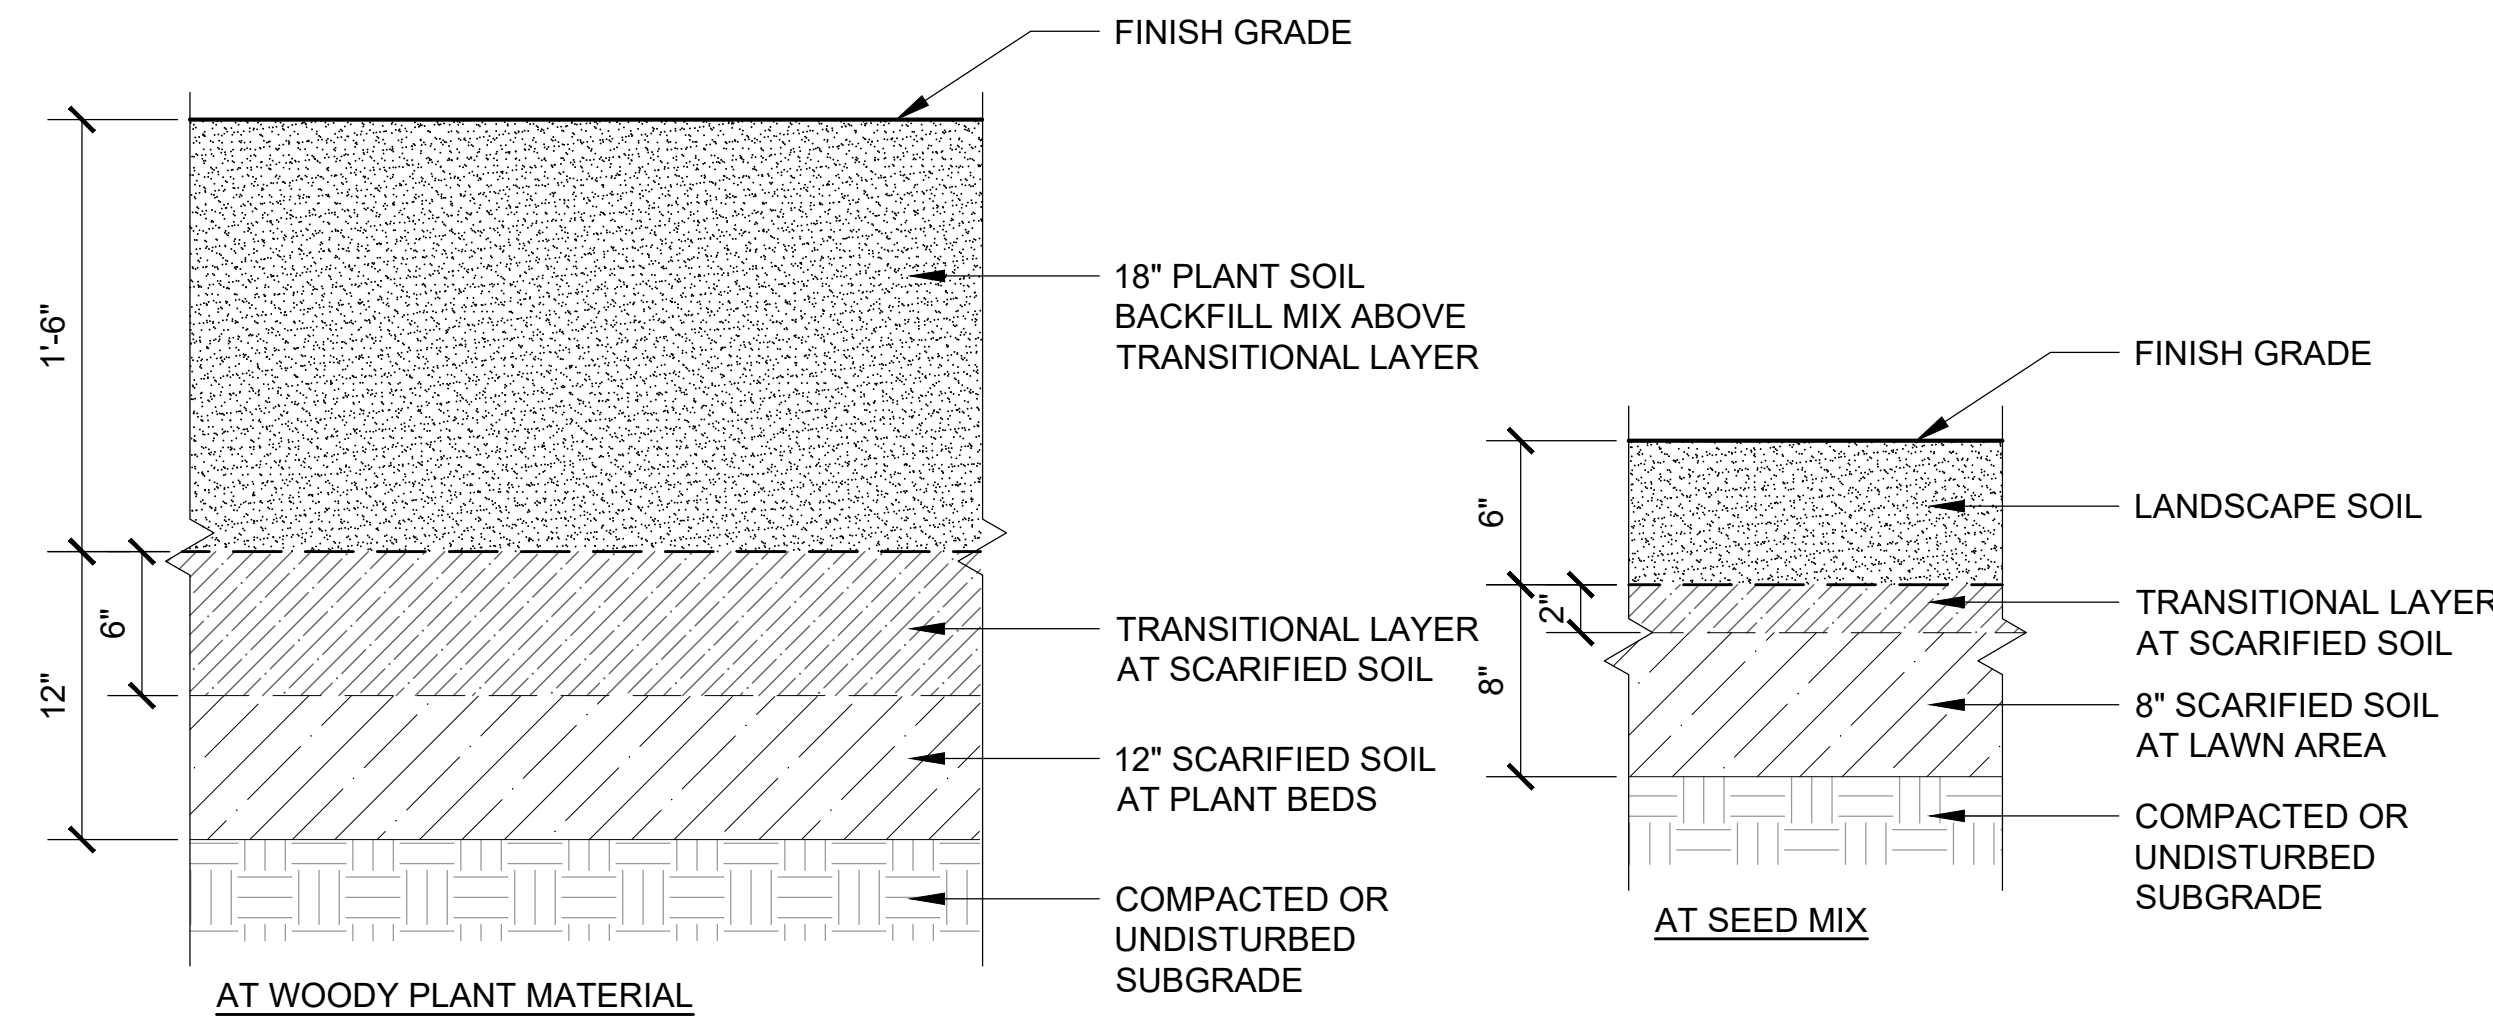

8 SOIL PREPARATION - FOR ALL BEDS AND SEEDS AREAS
SCALE: 1-1/2" = 1'-0"

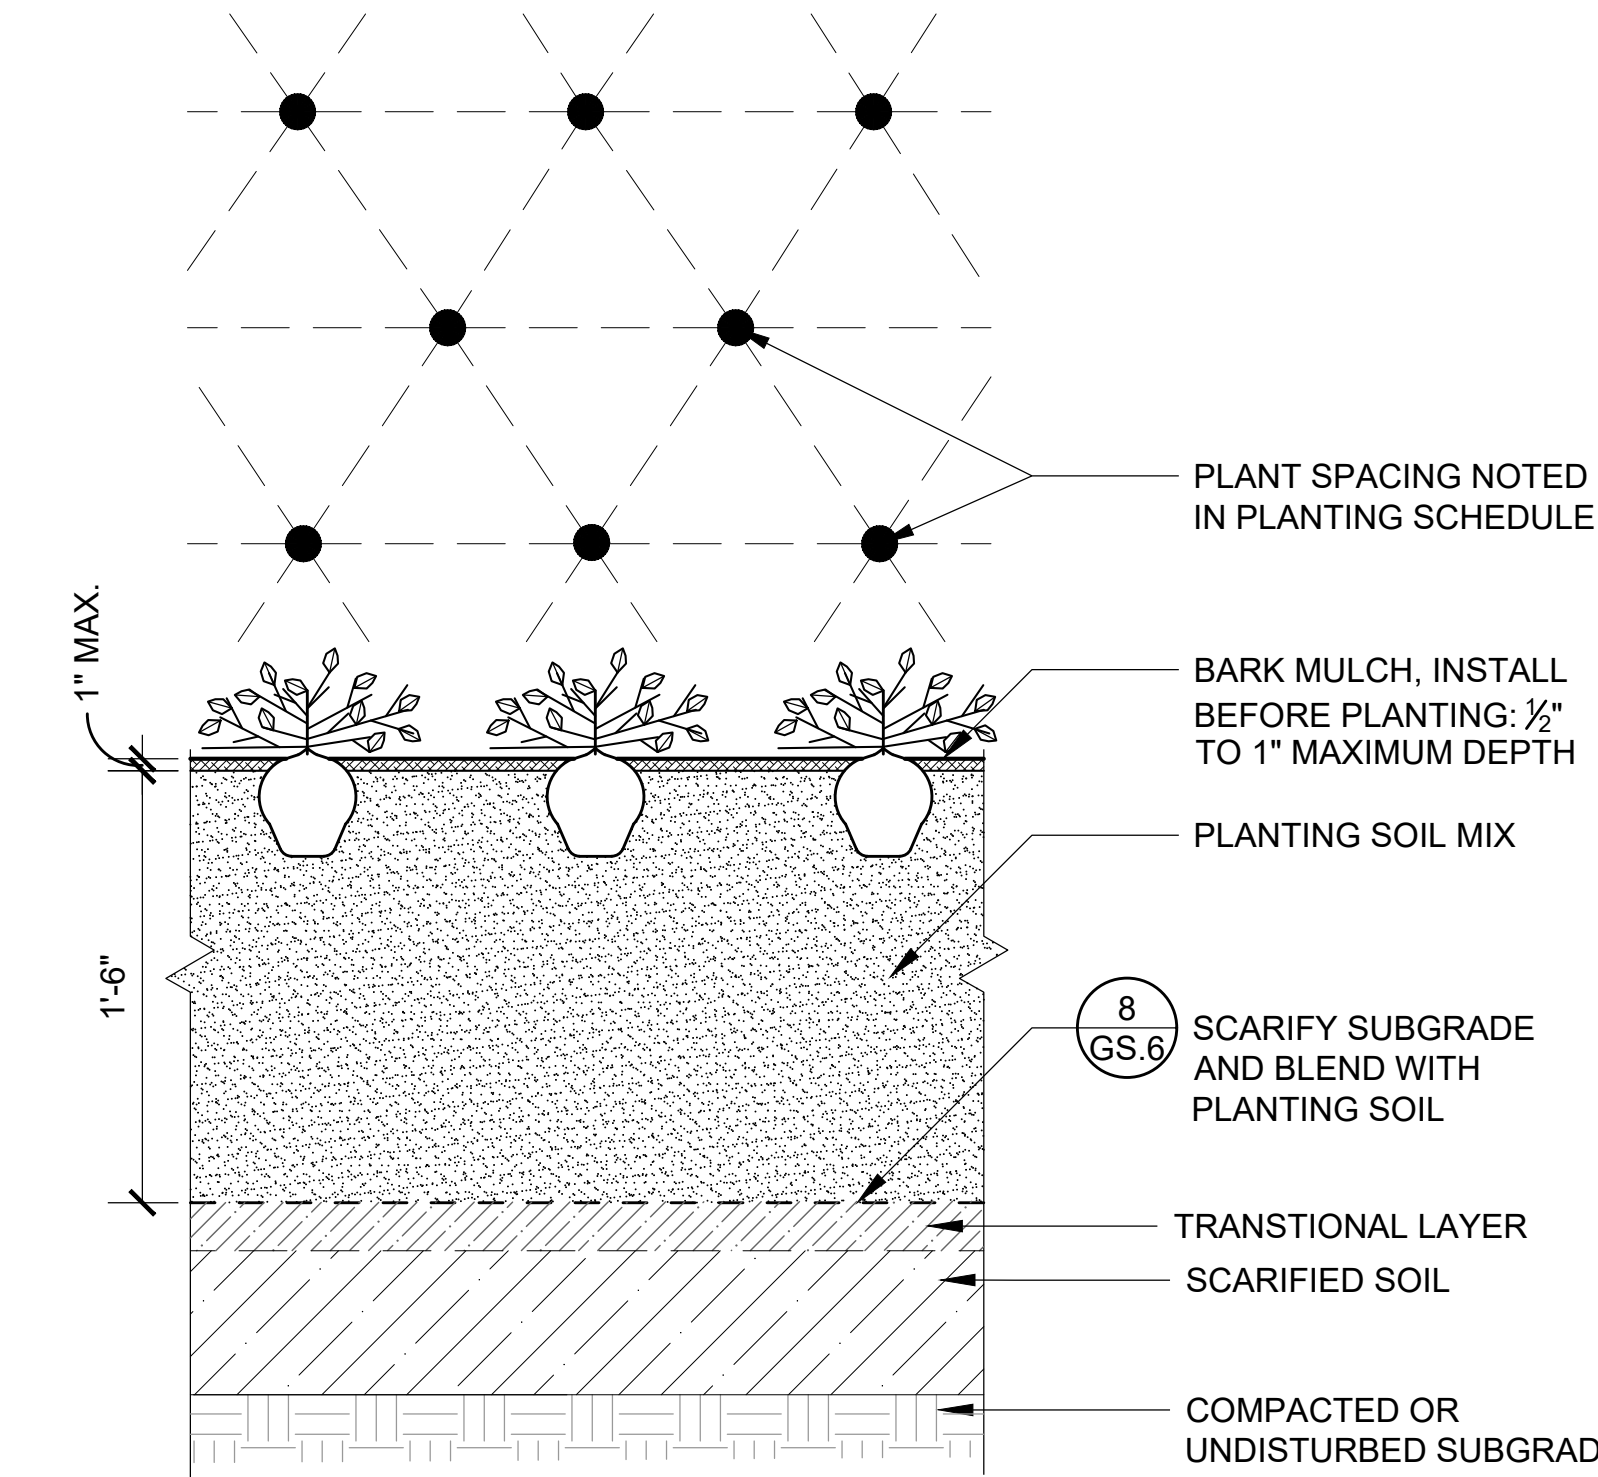

9 PERENNIAL / GROUNDCOVER PLANTING
SCALE: 1-1/2" = 1'-0"

NOT FOR
CONSTRUCTION

City Stamp

96-E-1, 96-E-1A, 96-E-2, 96-E-5,
96-E-4,
96-E-3, 96-F-2, 96-F-3, 96-F-4, 96-
F-5, 96-F-6, 96-F-9



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DRAWN BY NV
CHECKED BY IR

SHEET TITLE:

**Landscape
Details**

GS.6